June 19, 2019 FOI No: 2019-25

VIA E-MAIL - Redacted

Redacted

Dear Redacted

Re: Request for Records

Freedom of Information and Protection of Privacy Act

The City of White Rock has processed your request for access to the following records pursuant to the Freedom of Information and Protection of Privacy Act (the Act):

All permitting and bylaw enforcement records respecting:

14034 Marine Drive

PID: 001-763-440, Lot A, Plan NWP13312, Section 9, Township 1, New Westminster Land District

Access to these records is available. However, some of the records contain information that is excepted from disclosure under the Act. I have severed the excepted information so that I could disclose to you the remainder of the records as attached.

The severed information is excepted from disclosure under sections 22 and 15 of the Act. Severing under section 22 is necessary to avoid disclosing third-party personal information without permission. Severing under section 15 is necessary to protect the security of the subject property. All drawings showing interior floorplans have been withheld in their entirety. As a policy, the City will only disclose interior floorplans to a property owner or their agent.

Corporate Administration

P: 604.541.2212 | F: 604.541.9348

City of White Rock

WHITE ROCK
City by the Sea! www.whiterockcity.ca

Please contact our office if you have any questions or concerns.

Sincerely,

Ken Overton

Manager, Property, Risk Management, and FOI

604-541-2104

Att.

If you believe that the City of White Rock has been unreasonable in its handling of your request, you may ask the Information and Privacy Commissioner to review our response. You have 30 days from receipt of this notice to request a review by writing to:

Office of the Information and Privacy Commissioner 3rd Floor, 756 Fort Street Victoria BC V8W 1H2

Should you decide to request a review, please provide the Commissioner's office with:

- 1. your name, address and telephone number;
- 2. a copy of this letter;
- 3. a copy of your original request sent to the City of White Rock; and
- 4. the reasons or grounds upon which you are requesting the review.


Redacted S	5. 22	Location /4 5 5	t Danny	9 201 133
rchitect			e Zone Group	Type
ontractor's Address		Occupancy 7	Duraley.	
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escription of Construction		*	LOT	×10.1%1
ize 5 1.6 x 30.6	Storeys Rooms	Jelm Min. Yards: Front	R. Side 1 L. Side	7 Rear 25
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	INSPECTED	CONDITION	INSPECTED	CONDITION	INSPECTION REQUESTS
	Front Yard. 40	pears of	Insulation	Rock Wool	1 June 27/58
	R. Side Yard 7:2	p. ness	Rafters	2x40/60c	2. (July 2/50
	L. Side Yard · 7:2		Roofing	Caphalt	3/Valle /30/5%
7	Rear Yard	P	Chimney	Brick + J	4 Ring 1/2/58
	Excavation -		Fireplace	BuckyJ	- DATE OF INSPECTION
2	Footings.	es gren jelan :	Stucco Lath	mesk.	June 27/58
1:-	Foundation Walls '	84 10 com	Plaster Lath	gypoc Lath	
	¿Columns	11/ 0	Exterior Finish aidena	tustain	32 eld 30/58
	Beams	2166	Plaster	Pain	A aux 10/58
	Floor, Joist	2X10 @1600	- Stairs	RIF	5. Pont. 15/18
		1X6@16m	Exits	sip.	6.
25	Bridging		Eav. Tr. & Down Spout	alk "	7.
34 100/10	Headers & Trimmers		Furnace Room		8
	Sub Floors	alislan.	Toilet Clearance		Bidg. complete?
	Studding	2×40/600	Attic Trap	- 121	Occupied
	Bracing		Louvres	1	il Amin
	Sheathing	shiplan	Bathroom Vent		A. War
ti e	Fire Stop			1 1 1 1	Building Inspector

7)

Roll No. 310 BUILDING FACTORS Address 14034 - MARINE OR. A of a 0.73ac of E 9 T.1 SIZE OF BUILDING ______ft. x _____ft. = _____Sq. Ft. || Cubic Ft___ Basement: Yes No Full Partial Projections Chass 12-16 || Stories Size Concrete wall height 4 Frame-wall height 4 Class Type: Single family ____ Duplex ___ Row house ____ Floor (Dirt Wood Concrete Area Square ft. Conversion Apartment Other Basement Rooms: Fully partitioned V 3 wys Porches lumber of Rooms: Basement 4 Main floor 5 Rumpus room Size Bedroom Size Floor (Concrete Fir Tile Hardwood Type Sq. Ft. Second floor Third floor Fourth floor Open ____ Number of suites 2 Barrot Floor: Cheap Board Flat grain fir Flat grain fir Glassed-in Workmanship and Design Edge-grain fir Hardwood V Concrete slab Attic or Half-story: Irregularity Factor: Roof Frame Linoleum Tile (Asphalt Rubber Cork Open...... Closed Foundation: Wood posts, piers, or sills Interior Finish: Unfinished Boards Stairway to Sa. Ft. Perimeter wall (Concrete Brick Stone Fibreboard Plasterboard Painted Plaster Unfinished ____ Exterior Wall: Stucco Shakes Plywood Wall-papered Wainscoting Finished Wood shingles _____ Asphalt shingles____ Height of half-story stub Board and batten ____ Drop siding ___ Painted ____ Interior Trim: Fir Hardwood V Tar-paper Brick Stone Concrete block Cinder block Brick veneer Stone veneer Percentage of ground Remarks . Insulation: Ceilings Walls Floors Other Electrical: Nil 110-volt 220-volt Roof: Gable Hip Flat Gambrel Other Additions Heating: Type auto Furnace Low pitch Medium pitch High pitch HWEXKOL Number of dormers ____ Size____ Quality____ Firing method Remarks Roof Material: Tar-paper _____ Shakes ___ Plumbing: No plumbing And Toilet 3 Basin 2 Wood shingles ... Asphalt shingles V Tar and gravel... Bath 2 Shower AT Kitchen sink 2 H.W. tank & **€**aler Chimney and (or) Fireplace: Two-flue Laundry tubs V Septic tank Sewer V Well Main Well-pump (Hand _____ Motor ____) One-flue, wall-bracket One-flue, ground V Inside fireplace — Outside chimney and fireplace Year assessed - / S. Assessed by - a.C.



BUILDING FACTORS 374 - Address 14034 Manine Dr. AHA 0.73Ac PIN. NE 9 1, 13312 SIZE OF BUILDING ft x ft = Sq. Ft || Cubic Ft Class /-/0 Stories Projections Basement: Yes No Full Partial Class Size Concrete wall height Frame wall height Type: Single family Duplex Row house Square ft. I Floor (Dirt Wood Concrete Area Conversion Apartment Other Basement Rooms: Fully partitioned 13/4 1CAY! GOOD Porches -- -Number of Rooms: Basement 4 Main floor 5 Rumpus room..... Size Bedroom Size Floor (Concrete Fir.... Tile Hardwood... Sq. Ft. Second floor...... Fourth floor...... Fourth floor... Type Number of suites 2 Prosenies Open Glassed-in Ho(exTRA Floor: Cheap Board Flat-grain fir. Workmanship and Design - - 1- - - -Edge-grain fir Hardwood Concrete slab Attic or Half-story: Irregularity Factor: Roof Frame Linoleum Tile (Asphalt Rubber Cork Open____ Closed ____ Foundation: Wood posts, piers, or sills Interior Finish: Unfinished Boards Stairway to _____ Sq. Ft. Perimeter wall (Concrete Brick Stone Fibreboard Plasterboard Painted Plaster Unfinished..... Exterior Wall: Stucco Shakes Plywood Wall-papered Wainscoting Finished Height of half-story stub

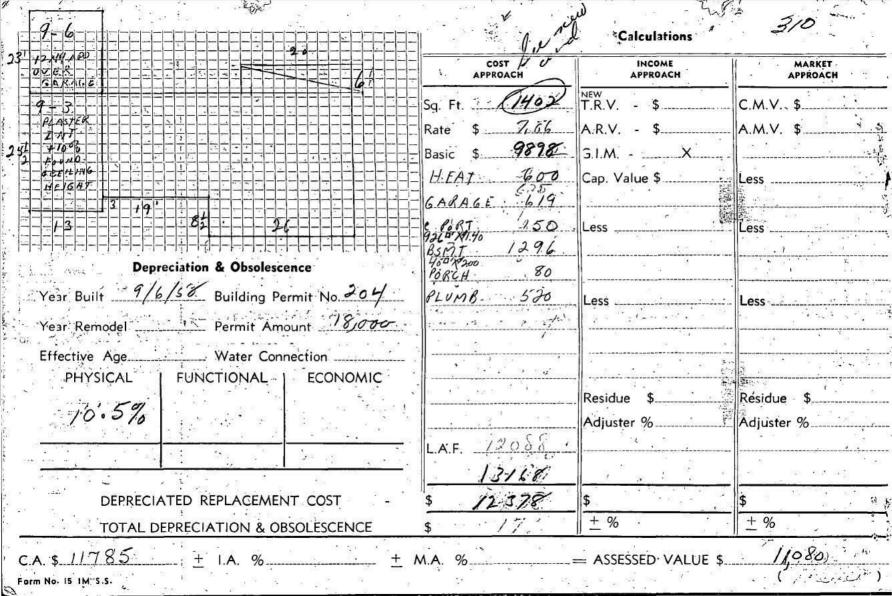Interior Trim: Fir Hardwood

Wood shingles _____ Asphalt shingles _____ Board and batten ____ Drop siding Painted ____ Tar-paper Brick Stone Concrete block Cinder block Brick veneer Stone veneer Roof: Gable Hip Flat Gambrel

Low pitch....... Medium pitch...... High pitch...

Number of dormers Size Quality

Roof Material: Tar-paper Shakes

Other __

Remarks Insulation: Ceilings Walls Floors

Heating: Type Cento EHH Firing method _____ Remarks _____

Electrical: Nil 110-volt 220-volt oil

Plumbing: No plumbing Toilet Basin

Dente 14/66 3 "plantes 1910 900 fin hose 9260 1 40 Aureson 40 60 400

Percentage of ground

floor

wall _____

compant 14/81.12 Bose Leat

Wood shingles... Asphalt shingles Tar and gravel. Other ____ Chimney and (or) Fireplace: Two-flue One-flue, wall-bracket One-flue, ground ... Inside fireplace Outside chimney and fireplace....

Bath Shower 07 Kitchen sink 2 H.W. tank Laundry tubs Septic tank Sewer Well Main Well-pump (Hand _____ Motor ____)

Assessed by - UK

THE CITY OF WHITE ROCK PERMIT TO BUILD

Dev. Permit No. Permit No. 16

Owner Redacted S. 22		Location 14034 Marine Urive
Address 1A034 Marine Architect Contractor Contractor's Address 13962		Lot Block Sec T Map District Fire Zone Group Type Occupancy Name of Project Addition
Description of Construction Size 12'x14' St		ing don Lot Size irreg. Approx. 70x Min. Yards: Front E R Side L Side Rear
Basement. Footings Columns Per Code Beams Per Code Stairways	Basemt. Ext. Walls Floors, Joists Live Loads	1st 2nd Roof stucco & siding duroid as per bldg. code
Int. Partitions Int. Finish drywall Int. Lath - Ceiling gyprog Insulation 3" batts	Gas Appliances	Fire Protection firestons Chimney Permit Fee \$ 8.00 Water Rates \$

Pariel 7 mal O 1/19/1200

	INSPECTED	CONDITION	1	INSPECTED	CONDITION	DATE OF INSPECTIO	N
70	Front Yard			Insulation	- 2	1. Clas 2/62	
	R. Side Yard			Rafters		2. apra 15-16 Forte	16.
	L. Side Yard			Roofing	31	3. Oct 17/62 For	a
	Rear Yard		i i	Chimney		4. ′	
35 	Excavation		, n	Fireplace	E /4	DATE OF INSPECTION	N
1	Footings	A November		Stucco Lath		1.7-ramposs. Vaus	. 3
	Foundation Walls			Plaster Lath	i.	2. Toolings and worth	
	Columns			Exterior Finish		3.	V
	Beams		14 T	Plaster	Winter Commence	4.	70
	Floor Joists	111.00	7. 粉料等。	Stairs	is in	5.	
	Ceiling Joists	10.7	<i>3</i> 1>	Exits	171	6.	
	Bridging			Eav. Tr. & Down Spout		7.	10000
	Headers & Trimmers	1 1 1 10 10 10		Furnace Room		8.	
0 6	Sub Floors	Part .		Toilet Clearance	* Y *	Bldg. complete?	
	Studding			Attic Trap		Occupied	
0 0	Bracing	2 2 2 2 2		Louvres	2	19	80 9
	Sheathing		٠.	Bathroom Vent			
`*	Fire Stop		18 L			Building Inspector	

Colin Atchison

From: Colin Atchison

Sent: Friday, July 16, 2004 1:36 PM

To: s. 22

Subject: suite status 14034 Marine Dr roll # 310

s. 22

Further to our conversation, the property art 14034 Marine Dr should be recorded as having a two sewer uses (2x sew 1). It was built originally as a duplex and that use still exists.


Thanks Colin

B.C. LAND SURVEYOR'S FORMS LOCATION CERTIFICATE OF: LOT A, SECTION 9, TOWNSHIP 1, NEW WESTMINSTER DISTRICT, PLAN 13312

(P.I.D. 001-763-440)


0 5 10
ALL DISTANCES IN METRES

SCALE-1: 250

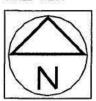

This document shows the relative location of the structures and features with respect to the boundaries of the parcel described above. It shall not be used to define property lines or property corners, and should be used in conjunction with a current title search to determine any charges which may affect land use.

LOT DIMENSIONS ARE FROM GROUND SURVEY BY MYSELF

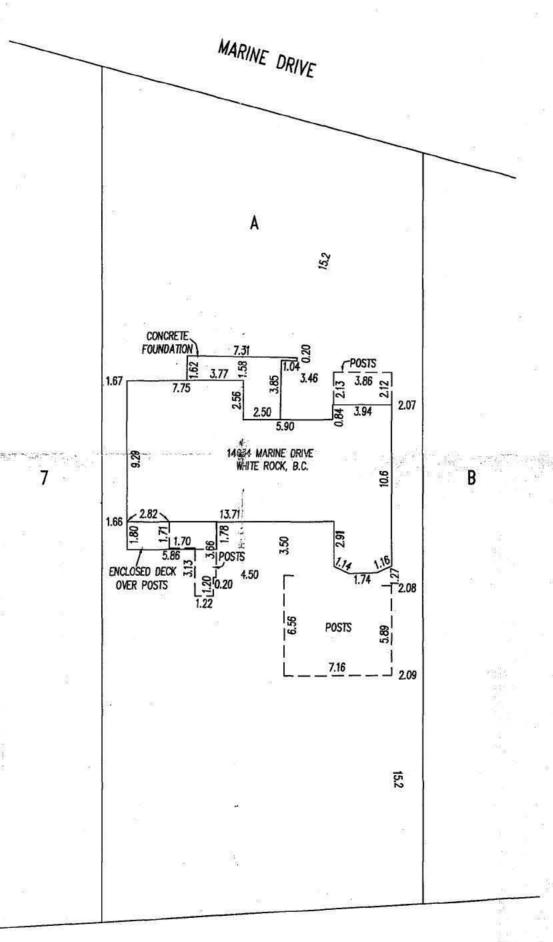

TERRY ROAD

This plan was prepared for municipal purposes and is for the exclusive use of our client.

All rights reserved. No person may copy, reproduce, transmit or after this document in whole or in part without the consent of the signatory.

The signatory accepts no responsibility or liability for any damages that may be suffered by a third party as a result of any decisions made, or actions taken

based on this document.

CERTIFIED CORRECT

Dated this 2/5t day of AOUTHEE. 2008
THIS DOCUMENT IS NOT VALID UNLESS
ORIGINALLY SIGNED AND SEALED. ©

FILE No. 17305FR-A OLSEN & ASSOCIATES BRITISH COLUMBIA LAND SURVEYORS 204-15585 24th AVENUE, SURREY, B.C. V4A 2J4 PHONE: 531-4067 Fax: 531-5811

TOPOGRAPHIC PLAN OF LOT A, SECTION 9, TOWNSHIP 1, NEW WESTMINSTER DISTRICT, PLAN 13312 (P.I.D. 001-763-440) ALL DISTANCES IN METRES SCALE-1: 250 68.20 MARINE DRIVE GUTTERLINE 67.58 61.6h . This document shows the relative location of the structures and features with 105'00'45" respect to the boundaries of 22.086 the parcel described above. It shall not be used to define property lines or property corners, and should be used in conjunction with a current title search to determine any charges which may affect land use. 20.30 LOT DIMENSIONS ARE FROM 17.17 GROUND SURVEY BY MYSELF GROUND ELEVATIONS ON THIS PLAN ARE DEEMED TO BE NATURAL GRADE. THIS PLAN DOES NOT CONSTITUTE A RESURVEY OF THE LEGAL BOUNDARIES OF THE TITLED LOT OR LOTS, IT IS 1.67 PEAK . 7.75 COMPILED FROM FIELD TIES AND 2.56 ELEV.=71.70 LAND TITLE OFFICE RECORDS. 2.07 MAIN FLOORJ 5.90 65.88 SLAB! ELEV.=67.55 ELEV.=66.44 В BASEMENT FLOOR **ENCLOSED** (ELEV.=64.93 13.71 DECK 79.55.50 1.66 DECK 7.85 64.83 DECK OVER 2 OPEN CARPORT 5.28 2.08 15.1 SIM 65 KJ 21.380 61,87 6134 6193 62,12 STM MH GUTTERLINE LEGEND SAN MH (2) STM MH → STORM MANHOLE CENTERLINE OF TRAVELLED PORTION SAN MH * SANITARY MANHOLE 62.18 65/8 NOTE - GROUND ELEVATIONS ON THIS PLAN ARE NOT TO BE USED FOR CONSTRUCTION BENCHMARK PURPOSES. TERRY ROAD A BENCHMARK MAY BE OBTAINED FROM THIS OFFICE. INDICATES LOCATION AND THIS PLAN WAS PREPARED FOR MUNICIPAL PURPOSES ELEVATION OF GROUND SHOT. CERTIFIED CORRECT AND IS FOR THE EXCLUSIVE USE OF OUR CLIENT. ALL RIGHTS RESERVED. NO PERSON MAY COPY, REPRODUCE, TRANSMIT OR ALTER THIS DOCUMENT IN WHOLE OR IN PART WITHOUT THE CONSENT OF THE SIGNATORY. ELEVATIONS ON THIS PLAN ARE DERIVED THE SIGNATORY ACCEPTS NO RESPONSIBILITY OR LIABILITY FOR FROM CITY OF WHITE ROCK BENCHMARK #88H3898

FILE No. 17305T

BASED ON THIS DOCUMENT.

ANY DAMAGES THAT MAY BE SUFFERED BY A THIRD PARTY

AS A RESULT OF ANY DECISIONS MADE, OR ACTIONS TAKEN

OLSEN & ASSOCIATES BRITISH COLUMBIA LAND SURVEYORS


204-15585 24th AVENUE, SURREY, B.C. V4A 2J4

LOCATED AT 140th ST. AND MARINE DRIVE.

PHONE: 531-4067

THIS DOCUMENT IS NOT VALID UNLESS

ORIGINALLY SIGNED AND SEALED.

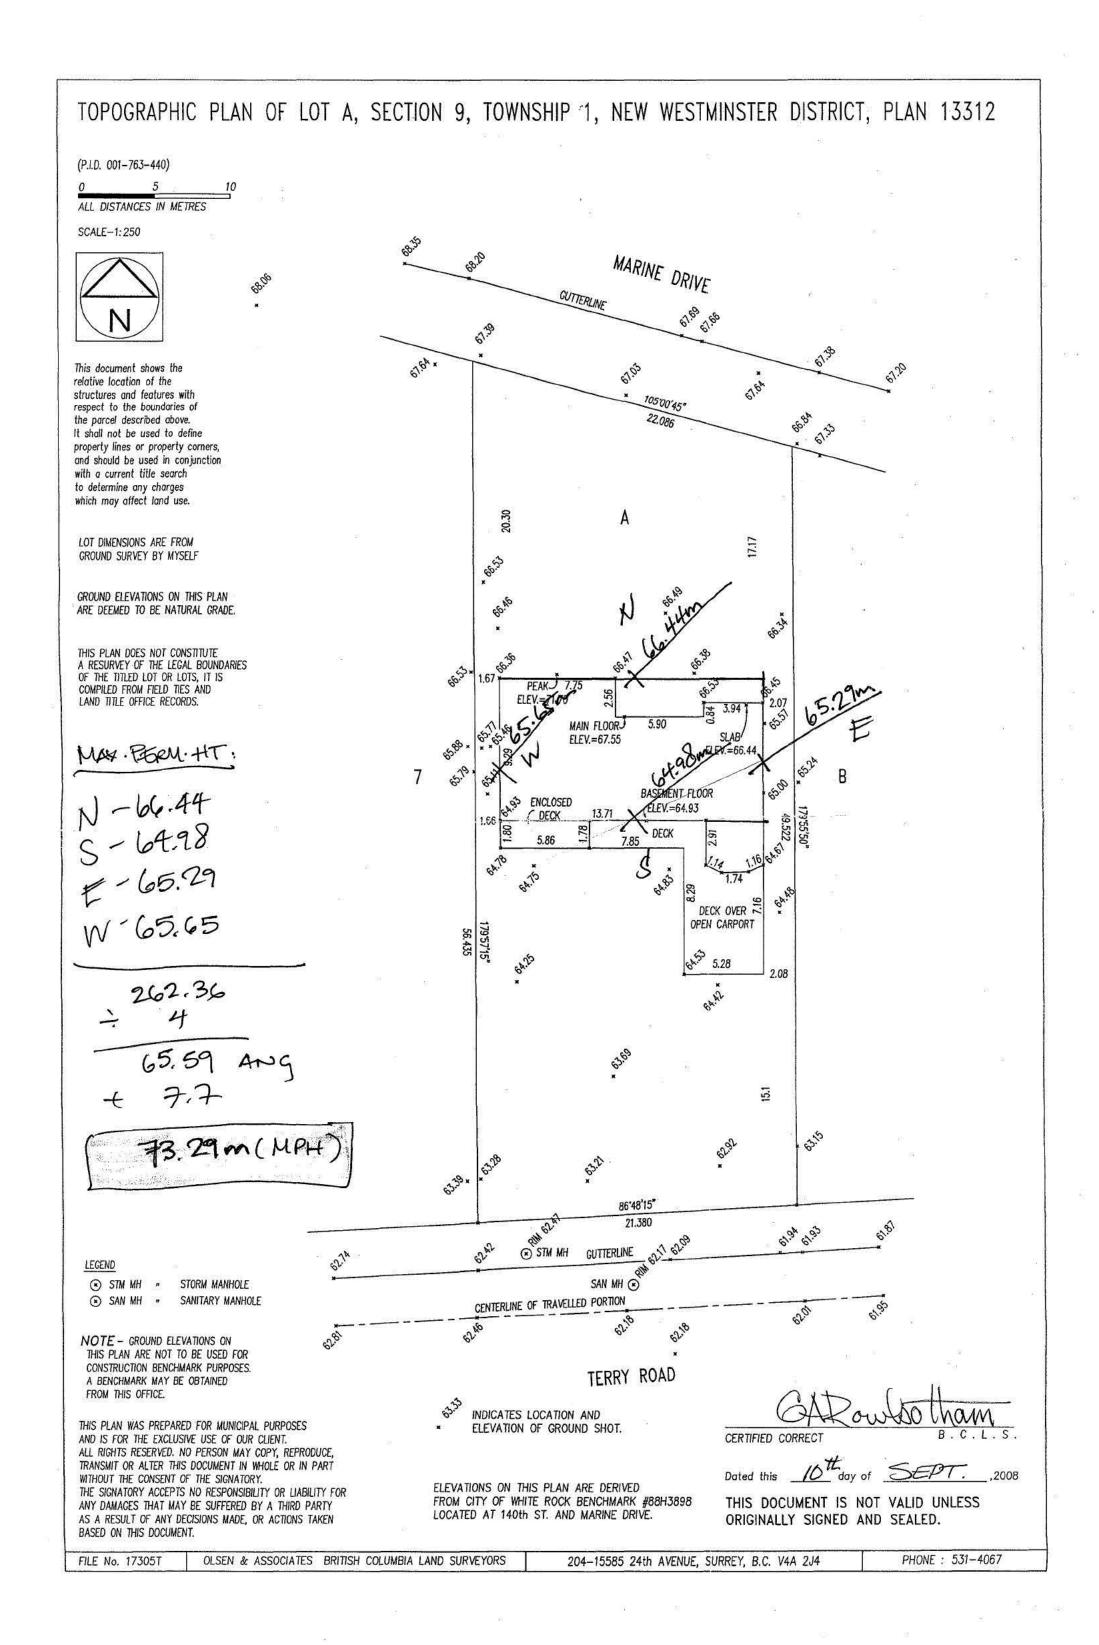

BUILDING PERMIT

DATE OF ISSUANCE: X

NOV 07 2008

BUILDING PERMIT No: 08-126

ROLL No: 310.000

14034 Marine Drive

Lot A, Sec 9, TP1, NWD, Plan 13312

RS-4

Residential

N/A

PROJECT ADDRESS:

LEGAL DESCRIPTION:

ZONE:

OCCUPANCY:

REGISTERED SUITE:

DESCRIPTION OF PROJECT:

700 S.F. second floor addition c/w decks and carport

OWNER:

OWNER'S ADDRESS:

AUTHORIZED AGENT:

BUILDER:

ARCHITECT ON RECORD:

ENGINEER ON RECORD:

×Redacted S. 22

Owner of Authorized Ageny

B.C.B.C. 1.1.2.4 Responsibility of Owner

Redacted S. 22

Owner/Builder

J.E | Silva Gutierrez (Structural/\$ Geotechnical)


Building Official

1) Neither the granting of a building permit nor the approval of the relevant drawings and specifications nor inspections made by the Authority Having Jurisdiction shall in any way relieve the owner of such building from full responsibility for carrying out the work or having the work carried out in full accordance with the requirements of the British Columbia Building Code.

INSPECTION INFORMATION

BOARD OF VARIAN	ICE APPROVED:		YES 🗆	NO 🗆	
TREE PROTECTION AREA:			YES 🗆	NO 🗆	
			YES ■	NO 🗆	
			YES ■	NO 🗆	
FORM SURVEY PL	AN RECEIVED:		YES 🗆	NO 🗆	
REGISTERED SUIT	E APPROVED:		YES D	NO 🗆	
Project Value:	Permit Fee:	Microfiche Fee:	Inspection fee:	Building Size:	Total:
\$300,000	\$2,788.25	\$50.00		700 s.f. addition	\$2,838.25
REMARKS:					
		\$	Soft.		
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700 Y 24 T 24 T 25 T 27					

BUILDING PERMIT

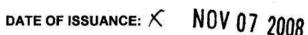

BUILDING PERMIT No: 08-126

ROLL No:

14034 Marine Drive

Lot A. Sec 9. TP1. NWD. Plan 13312

310,000

RS-4

Residential

N/A

PROJECT ADDRESS:

LEGAL DESCRIPTION:

ZONE:

OCCUPANCY:

REGISTERED SUITE:

DESCRIPTION OF PROJECT:

700 S.F. second floor addition c/w decks and carport

OWNER:

OWNER'S ADDRESS:

AUTHORIZED AGENT:

BUILDER:

ARCHITECT ON RECORD: ENGINEER ON RECORD:

×Redacted S. 22

Owner or Authorized Agent

B.C.B.C. 1.1.2.4 Responsibility of Owner

1) Neither the granting of a building permit nor the approval of the relevant drawings and specifications nor inspections made by the Authority Having Jurisdiction shall in any way relieve the owner of such building from full responsibility for carrying out the work or having the work carried out in full accordance with the requirements of the British Columbia Building Code.

Redacted S. 22

Owner/Builder

J.E Silva Gutierrez (Structural & Geotechnical)

Building Official

INSPECTION INFORMATION

MAX. PERMITTED	HEIGHT: 73	.29m (MPH)	ANGLE OF CONTA	INMENT:	N/A	
ACTUAL HEIGHT:	-		ACTUAL ANGLE:			
BOARD OF VARIANCE APPROVED: TREE PROTECTION AREA: STRUCTURAL ENGINEER ON PROJECT: GEOTECHNICAL ENGINEER ON PROJECT: FORM SURVEY PLAN RECEIVED: REGISTERED SUITE APPROVED:			YES YES	NO		
Project Value:	Permit Fee:	Microfiche Fee:	Inspection fee:	Building Si	ze: To	tal:
\$300,000	\$2,788.25	\$50.00	-	700 s.f. addit		38.25
REMARKS:	·				7	
2006	BCBC					
				-		
	., 5					
OCCUPANCY / FIN	AL GRANTED:			··· Date	•	



DEVELOPMENT SERVICES

15322 Buena Vista Avenue, White Rock, B.C. V4B 1Y6 Phone: (604) 541-2136 • Fax: (604) 541-2153

Inspection Report

NAME:	Redacted				PERMIT No.:	08.1	26
ADDRESS: _	14034	Marine	Dr.		SHEET No.:		
TYPE OF INS					DATE:	Aug L	109
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DATE:		T 51		5	X		
	Please sign this	form when the w	ork is com	pleted and r	eturn to the abov	e departme	nt.



Lower Mainland North Regional Office: Unit 24 - 2773 Barnet Highway Coquitlam, BC V3B 1C2 Lower Mainland South Regional Office: 101 - 22259-48th Avenue Langley, BC V3A 8T1

Vancouver Island Regional Office: 3rd Floor, 4243 Glanford Avenue Victoria, BC V8Z 4B9 Northern Interior Regional Office: 3235 Westwood Drive Prince George, BC V2N 1S4

Southern Interior Regional Office: 1913 Kent Road Kelowna, BC V1Y 7S6 Head Office: 88 - 6th Street, Suite 400 New Westminster, BC V3L 5B3

ELECTRICAL CONTRACTOR AUTHORIZATION AND DECLARATION OF COMPLIANCE ELECTRICAL INSPECTION REQUEST

Note: The information on this form is collected to administer the provisions of the BC Safety Standards Act. If you have questions about the collection, use

Permit Number:	f faxing this document, ple	**	766 G 80 80	Photos .		water to the second sec
Installation name:	Redacted S. 22	<u> </u>	Location	of Work Site:		74 1 1 1 1 1 1 1 1 1 1 1 1 1 1 1 1 1 1 1
Suite no.:	Civic no. 140 34	Street name:	Manie		Street type: DRU	NSEW:
City:	· AV A		MAMNE		2140	<u> </u>
	した Ctrical Contractor:	HITE POO	<u>k</u>)	8 No. 3 No.	
	ontractor (EC) name (please p	orint):	.6 . 6 .	engan saista an a		
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City:	A330056		B 4 s		X	as in the cons
C. Declaration (t	o the electrical inspection	office/and supply au	thority):	Total .	The second of the second	n (5 %
Field Safety Represen	tative No. (FSR):	75	FSR Classes:	RC	* X X	**************************************
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British Columbia."	n authorized under the above	e mentioned permit has	been installed to co	omply with the	Safety Standards Act	and Regulations of
	tative (FSR) Signature:		N	Date:	YYYY M	M DD
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		×	Work in Progress	All wor	k is Complete	Installation Safe
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Service Character Service Char	etrode: Rod	Ufer	Plate Oth	ase L	Ø	kv



DEVELOPMENT SERVICES

15322 Buena Vista Avenue, White Rock, B.C. V4B 1Y6

Phone: (604) 541-2136 • Fax: (604) 541-2153

Inspection Report

NAME:	Redacted S	5. 22	PERMIT No.:	126
ADDRESS	: 14034 M	aring Dr.	SHEET No.:	· · · · · · · · · · · · · · · · · · ·
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SIGNATUE	RE:	INS	PECTOR:	
DATE:		莊 - 13		

Please sign this form when the work is completed and return to the above department.



DEVELOPMENT SERVICES

15322 Buena Vista Avenue, White Rock, B.C. V4B 1Y6

Phone: (604) 541-2136 • Fax: (604) 541-2153

Inspection Report

Redacted S. 22	PERMIT No.: 08. 126
ADDRESS: 14034 Marine	
TYPE OF INSPECTION:	DATE: April 01/09
TYPE OF INSPECTION: AREA OF INSPECTION: Traviation (Garage) 4	Bedeflow device
Garage insulation Approved	d.
8	1
Button device Approved	(Duble check)
	77 STEERING M
	The state of the s
	- 14.200 miles (F. 17. 17. 14. 14.200 miles (F. 17. 14.200 m
	SIM
SIGNATURE: INSPECT	OR:
DATE:	

Please sign this form when the work is completed and return to the above department.

15322 Buena Vista Avenue, White Rock, B.C. V4B 1Y6 Telephone: (604) 541-2136 Fax: (604) 541-2153

Permit Number:	5526,
Date: ADYI	1 20/09

APPLICATION FOR PLUMBING PERMIT

ocation of Worldwner:	k: 1403 VA A	34 N EVELOPI	MARIN MENTS	IE D	R. Ph	one:	cupancy:	Kesiden 3055	F.Q. Numl	_Type of V	Vork: New	Existi	ng □, Addit	ional 🗅
wish to apply							150	N	Suomeso	LIGOTIOC.			,pp.ned 1 01	22
Floor	Water Heater	Water Closets	Wash Basins	Bath Tubs	Showers	Kitchen Sink	Wash Tubs	Automatic Washer	Floor Drains	Urinals	Dish Washer	Hose Bibs	Sprinklers	Other Fixture:
Basement		*		45				8			1			
Main						•		11 24						1
Second						8	E 0							11.55
Third	Α.			*!i						A				
Fourth	a	19					K N					- B		
Fifth			70				rter 1							
Sixth				11 -										
TOTAL				Process Co. Co.			\$4		1			13	Apr/2009	IN R: 10707
Fixture Units						25 91	77 H				,	- W	JØ9 LORI	~_
Vater Service S	Size: 1		Total	Fixture Ur	nits:	N 2	Total N	lo. of Fixtures	s:_/	PERM	IIT PEE: \$)	2	5D.00	50.00 50.00 8:2009042002 / D:2129
Signature (Ap	plicant) (-2					8 "	Signa	ature (Insp	ector)			169 01.000
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DEVELOPMENT SERVICES

15322 Buena Vista Avenue, White Rock, B.C. V4B 1Y6

Phone: (604) 541-2136 • Fax: (604) 541-2153



NAME: _		PERMIT No.: 08 104
ADDRESS	s: 14034 Marine	SHEET No.:
	INSPECTION:	DATE: April 17/09
	INSPECTION: Garage (Frame)	\
ANEA OF	INSPECTION. CANTAGE (TOTTA	
		** 200°
	1) Complete ventilation	hous as discussed
94		8
	2) Insulction in alling	to not be thicker than
2 2	b" inches rei vert	ation
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		XIA
SIGNATUF	RE: IN	SPECTOR:
DATE:		
	Please sign this form when the work is complete	ed and return to the above department.



DEVELOPMENT SERVICES

15322 Buena Vista Avenue, White Rock, B.C. V4B 1Y6

Phone: (604) 541-2136 • Fax: (604) 541-2153

Inspection Report

NAME: _	Redacted S. 22	PERMIT No.: 03.124
ADDRESS	: 14034 Marine Dr.	SHEET No.:
TYPE OF	INSPECTION: <u>Plumbins</u>	DATE: April 8/09
AREA OF	INSPECTION: Master Ensuite tol	trap
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	tub trap tested + Appro	ud.
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SIGNATUI	RE: INSPECTOR	
DATE:	The second secon	

Please sign this form when the work is completed and return to the above department.



DEVELOPMENT SERVICES

15322 Buena Vista Avenue, White Rock, B.C. V4B 1Y6 Phone: (604) 541-2136 • Fax: (604) 541-2153

Holle. (604) 541-2130 - Fax. (604) 541-2133

Inspection Report

NAME:Redacted S	5. 22	PERMIT No.:	3.126
ADDRESS: 14034 1	Marine	SHEET No.:	
TYPE OF INSPECTION:		DATE: 746	26/09
AREA OF INSPECTION:	Frame		
garage 1) Cravata (2" vant	roof venti	lation as discussion ch and)	d
* High du	ensity Rat	agriad under o	Leck
		Recall	
SIGNATURE:	1)	INSPECTOR:	7
DATE:	S. 10000-1		e v

Please sign this form when the work is completed and return to the above department.



RECEIVED FEB 1 1 2005

Address: Unit 100-12099 237 St. Maple Ridge, BC, V4R 2C3

Cell: 778.928.7589

Phone: 778.785.7729

To: Nova Developments Date: 06 02 2009
From: Dorge Silva p. Eng
site: 14034 Marine Dr, white bock (Garage enclosure)
Subject: Excavation Inspection Footing Inspection Other:
Compaction Inspection Framing Inspection
Cornerstone Engineering conducted a
footing inspection for garage @ 14034
Marine Dr White Rock.
Forms 1 steel bars are in place
and as per cornerstone Eng regarrements.
According to our inspection, it's ok
to proceed.
the state of the s

SCHEDULE C-B

Forming Part of Subsection 2.2.7, Division C of the British Columbia Building Code

Building Permit No.

and Signature)

Date

ASSURANCE OF PROFESSIONAL FIELD REVIEW AND COMPLIANCE

Notes: (i) This letter must be submitted after completion of the project but prior to final inspection by the authority having jurisdiction. A separate letter must be submitted by each registered professional.

(ii) This letter is endorsed by: Architectural Institute of BC, Association of Professional Engineers and Geoscientists of BC, Building Officials' Association of BC, and Union of BC Municipalities.

(iii) In this letter the words in italics have the same meaning as in the British Columbia Building Code.

To: The authorit	y having jurisdiction
City of white	y having jurisdiction Rock

Name of Jurisdiction (Print)

TOTAL IN SET OF SHIP OF

Structural & Geotechnical

Discipline (e.g. Architectural, etc.) (Print)

Proposed house addition

Name of Project (Print)

14034 Marine Dr

Address of Project (Print)

Lot A, LD 36, Sec 9, TWP1, NWD NE1/4, Plan 13312

Legal Description of Project (Print)

(Each registered professional shall complete the following:

Jorge Silva

Name (Print)

#100 12099 237th St


Address (Print)

Maple Ridger BC, V4R 20

HT8) 928-7589

Phone No!

I hereby give assurance that

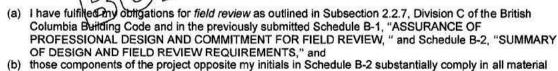

 (b) those components of the project opposite my initials in Schedule B-2 substantially comply in all material respects with

 the applicable requirements of the BC Building Code and other applicable enactments respecting safety, not including construction safety aspects, and

(ii) the plans and supporting documents submitted in support of the application for the building permit,

(c) I am a registered professional as defined in the British Columbia Building Code.

(If the registered professional is a member of a firm, complete the following:)

Cornerstone Geo-Structural Engineering Limited

I am a member of the firm ______and I sign this letter on behalf of the firm.

(Print name of firm)

Note: The above letter must be signed by a registered professional. The British Columbia Building Code defines a registered professional to mean

(a) a person who is registered or licensed to practise as an architect under the Architects Act, or

 a person who is registered or licensed to practise as a professional engineer under the Engineers and Geoscientists Act.

CRP's Initials

1 of 1



DEVELOPMENT SERVICES

15322 Buena Vista Avenue, White Rock, B.C. V4B 1Y6

Phone: (604) 541-2136 • Fax: (604) 541-2153

Inspection Report

Redacted S. 22	PERMIT No.: 08.124
ADDRESS: 14034 Marine Dr.	SHEET No.:
TYPE OF INSPECTION:	DATE: 700 6/09
AREA OF INSPECTION: Insulation / Frame	
Fram Approved (house of Recall	anly)
Recall	for garage
Insulation	j · J
i) Caulle bottom partas in	dining room area
Insulation Approved subject	ct to about
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	01
SIGNATURE:INSPECTOF	
DATE: Please sign this form when the work is completed and re	



DEVELOPMENT SERVICES

15322 Buena Vista Avenue, White Rock, B.C. V4B 1Y6

Phone: (604) 541-2136 • Fax: (604) 541-2153

Inspection Report

NAME:	PERMIT No.: 08.126
ADDRESS: 14034 Marine Dr.	SHEET No.:
TYPE OF INSPECTION: Dumbins	DATE: 7eb 3/09
AREA OF INSPECTION: tub & Shower tray	
	(1969) V =
i) Moster Ensuite tob to	be fisted.
Tub/shower trap app	proved
Recall for about	
	94 On the Control of
8	
	A
SIGNATURE: I	INSPECTOR:

Please sign this form when the work is completed and return to the above department.



DEVELOPMENT SERVICES

15322 Buena Vista Avenue, White Rock, B.C. V4B 1Y6

Phone: (604) 541-2136 • Fax: (604) 541-2153

Inspection Report

NAME:Redacted S. 22	PERMIT No.: 08.126
ADDRESS: 14034 Marine Dr.	SHEET No.:
TYPE OF INSPECTION: plumbins	DATE: Jan 30/09
AREA OF INSPECTION: DWV + Waterlin	15
* Soni outfall fasted. 200 pri test witnessed	,
N **	
i) Add clips on waterlines as	s discussed.
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DWV Approved.	to about
DWV Approved.	
Rocall for trap test	
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	2. 2
	11
SIGNATURE: INSPECTOR	
DATE: Please sign this form when the work is completed and ret	ourn to the above department.



DEVELOPMENT SERVICES

15322 Buena Vista Avenue, White Rock, B.C. V4B 1Y6

Phone: (604) 541-2136 • Fax: (604) 541-2153

Inspection Report

NAME:	PERMIT No.: 08 126
ADDRESS: 14034 Marine Or.	SHEET No.:
TYPE OF INSPECTION:	DATE: An 29/09
AREA OF INSPECTION:	
All plumbing mand	tions to be completed.
2) "c" Letter from Strudu	oral Ensineer
18) Fire Stop at pipe cho	ase at limb closet
(4) Enlarge crawlapace acc	155 as discuss
VS) Fire Stop back walls	in bosement
15) Fire Stop back walls	hase in basement 5 Warne
	icall
SIGNATURE: INSPEC	CTOR: CONTRACTOR OF THE CONTRA
DATE:	
Please sign this form when the work is completed ar	nd return to the above department.



PHOENIX VINYL SUNDECKS LTD.

January 26, 2009

To Whom It May Concern:

Job Site: 14043 Marine Drive White Rock

Product: 60ml - 3ply Reinforced Mist Vinyl

This is to confirm that Phoenix Vinyl Sundecks Ltd installed Deck Rite 60ml Reinforced Vinyl – Mist color the three decks at the above mentioned Job Site address.

If you have any questions, please feel free to call the office.

Sincerely,

Kelly LaPlante Administration

Phoenix Vinyl Sundecks Ltd



INTRODUCTION

At the request of Phoenix Vinyl Sundecks, Ltd., the Coquitlam, British Columbia facility of Intertek Testing Services NA Ltd. (Intertek), has conducted product evaluation testing on a PVC Sheet-Applied Waterproof Decking Membrane. The testing was conducted in accordance with CAN/CGSB 37.54-95 <u>Polyvinyl Chloride Roofing and Waterproofing Membrane</u>.

In addition, the following tests, typical to walking surfaces, were conducted:

- 1) Abrasion resistance in accordance with ASTM D 1242
- 2) Slip resistance in accordance with CAN/CGSB 75.1

The material tested was independently sampled and selected at Phoenix's Langley facility on May 12, 2003 by Geri Nishio, an authorized representative of Intertek Testing Services NA Ltd.

PRODUCT DESCRIPTION 1

Product Name:

Deck Rite 60 mil 3 ply/Reinforced

General Description:

Sheet vinyl waterproofing membrane with embedded reinforcement

Thickness:

60 mil

Application:

HB Fuller Contact Cement

PRODUCT DESCRIPTION 2

Product Name:

Deck Rite 60 mil Fleece Backed

General Description:

Sheet vinyl-waterproofing membrane with non-woven polyester backing

Thickness:

60 mil

Application:

HB Fuller Contact Cement

TESTING CONDUCTED

CAN/CGSB 37.54 p. 7.3.1 Overall Thickness

CAN/CGSB 37.54 p.7.3.2 Coating Thickness

CAN/CGSB 37.54 p.7.3.4 Breaking Strength and Elongation

CAN/CGSB 37.54 p.7.3.5 Lap Joint Strength

CAN/CGSB 37.54 p.7.3.6 (ASTM D1790) Low Temperature Impact

CAN/CGSB 37.54 p.7.3.7 Resistance to Heat Aging

CAN/CGSB 37.54 p.7.3.8 Low Temperature Flexibility

CAN/CGSB 37.54 p.7.3.9 Resistance to Accelerated Aging.

CAN/CGSB 37.54 p.7.3.10 Water Vapour Transmission

CAN/CGSB 37.54 p.7.3.11 Water Absorption

CAN/CGSB 37.54 p.7.3.12 Dimensional Change After Stress Relaxation

(Without Loading)

CAN/CGSB 37.54 p.7.3.13 Dimensional Change After Stress Relaxation

(With Loading)

CAN/CGSB 37.54 p.7.3.14 Cone Penetration

CAN/CGSB 75.1 Slip Resistance

ASTM D 1242 Abrasion Resistance

CONCLUSION

The two membranes, 60 mil - Reinforced and 60 mil - Fleece Backed, as tested and reported herein, have both met all requirements prescribed in CAN/CGSB-37.54-95. In addition, the two products tested have met the following "pedestrian traffic" deck requirements:

- Abrasion Resistance testing as required by ICBO-ES, AC39 <u>Acceptance Criteria for Walking Decks</u>, and as historically accepted by CCMC for <u>PVC Sheet-Applied Waterproof Decking Membrane</u> (Exposed to Light Pedestrian Traffic)
- Slip Resistance testing historically accepted by CCMC for <u>PVC Sheet-Applied Waterproof Decking Membrane</u> (Exposed to Light Pedestrian Traffic)

INTERTEK TESTING SERVICES NA LTD.

Reported by:

Geri Nishio

Technician, Construction Products

Reviewed by:

Cam Robinson, P.Eng.

Manager, Construction Products

GN/ahvs

6048505115

Mechanical Ventilation Checklist B-Distributed

Previously Checklist C (per former 1998 BCBC)

This Checklist is for use with forced air heating systems where the heating duct system distributes ventilation air.

Civic Address	14034 Marine	Or		Permit	No. 08-126
	Number of Bedrooms	4	(A) wind	low (minimum	om with an openab n dimensions apply ing interior door.
	Total Interior Volume of Dwelling	33300f	yolu	me must inch	de joist space.
5 ACH (air cl	eanges/hr) = Volume x 0.5 ÷ 60 =	277.5 cfr	(B) 5 A	mst appliance TH may requi	s exceeding re make-up air.
. Principal Fa	10 .				
b) Principal Make Byz Sones: Inter Maximum allowed: Pan Location c) Principal Fan Duct size	val Continuous Continuous	C) I some in Box E al Smooth	Eox E Man Make-up A	cfm cfm cfm cfm cfm cfm	(D) (E) d is 110 cfm if a Step 4.
Room	Fan Make & Model	Fan			ameter (in)
The season was		Code Reg'd Min e.z.w.c. per Table 9.32.33.B	actual Fan CFM e.2"W.C. per Mand, Rating	Table 9.3 Smooth	2.3.9* Flex
KIT	Brown GPRYALN	80	190	16	
Pordes	Broan SBOU	50	90		5
ensuite	Broam "	50	80		5
12	Acoust n	60	4 0		1

* For fan capacities exceeding Table 9.32.3.9, follow manufacturer's installation instructions or use good engineering practice to size duct. See Ventilation Guidelines Appendix page 24-A.

Checklist B1

J. IVAL F VA (Naturally Aspirated Fuel Fired Vented Appliance) and/or I	Radon Gas present in dwelling unit?
Yes, Proceed to Step 4 & 5	No, Omit Steps 4 to 8.
4. Active Make-Up Air Duct for Principal Fan: Per S air duct into the furnace geturn air plenum not more than 15ft (unless fornace cabinet. In locations with winter design temperature less the connected with principal ventilation air fan. Damper make	ss a flow control device is used) or less than 10ft from the an -10° C, this duct must have a motorized damper inter-
5. Exhaust Appliance present which exceeds Box B 0.	
6. No radon risk and only NAFFVA present is solid fr	12 (A. 6)
7. Use Passive Make-up Air for Exhaust Appliance with	actual installed exhaust rate of 126 cfm or less:
Appliance Cfm Passive Make-up A	ir Duct Sized to Table 9.32.3.8:inches
8. Use Active Make-up Air for Exhaust Appliance with ac Make-up Air Fan required: Fan Make Model	*Exhanst Appliance Cfm
Duct diameterinches Fan LocationFan duc	*must equal actual installed exhaust rate of appliance.
a) Active Make-up Air delivered to an Unoccupied Area i) Tempering Required per 9.32.4.1.(4)(a). Show calculation & describe how make up air will be tempered ii) Transfer Grill Required: Size to Table 9.32.3.8 (or 1 sq in Transfer grill size sq. in. Loca iii) Additional Tempering Required per 9.32.4.1.(4)(b) before describe how make-up air will be further tempered to at least 54°F (12°C).	ed to at least 34°F (1°C) before entering unoccupied area. n of gross area per 2 cfm): tion ore transfer to occupied area: Show calculation and ast 54°F (12°C).
Installer Certification: I hereby certify that the design and installation of the ventilation sys	Date
Print Name CORY RODGERS Signature Print Name CORY RODGERS	2006 TECA Ventilation Certification Stamp
Company ALPHA HOME ENERGY Phone 604 8521212	TECA Cory F. Rodgers #VG-008 Checklist B2
	teca Ventilation Guidelines 17



Address: Unit 100-12099 237 St. Maple Ridge, BC, V4R 2C2

Cell: 778.928.7589 Phone: 778.785.7729

To: Nova Developments	Date: 14 MO118 2009
From: Jorge Silva, P. Eng	AND
Site: 14034 Marine Dr Surrey	
Subject: Excavation Inspection Footing Inspection Other:	
Compaction Inspection Framing Inspection	
Cornerstone Engineering conducted	a framing
a sheating inspection @ 14034	Marine Dr.
Trusses, girders, beams in built-up	Columns
were inspected.	
All 11 11 1	n place.
and as per cornerstone Engineers	
Sheating as per BCBC 2006.) 17
	ok to
proceed to our inspection, it's	<u> </u>
2 X	energy of the second
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	and the second s
	C. C. Charles Company of Manager Company

McRAE'S SEPTIC TANK SERVICE

(FRASER VALLEY LTD.)
MODERN TANK TRUCKS

BOX 78, 28944 DOWNES RD. ALDERGROVE, B.C. V4W 2T7 PHONE: 604-856-8344, 604-534-2833, 604-826-7934, 604-792-3600 1-888-894-4411

FAX: 604-856-0763 Website: www.mcraeseptic.com

24 HOUR EMERGENCY SERVICE FAMILY OWNED & OPERATED SINCE 1951



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		DATE:	Jas. 15_	200	<u> </u>
Nova Group	develor.	. 1.		**	ø.
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	The state of the s		PHONE #	· · · · · · · · · · · · · · · · · · ·	
		POSTAL	CODE:		
14034 Marie	on Sey.	JOB NO	P.O. I	NO.	
SEPTIC TANK	CLEAN L	INES	☐ ENZYMES	1	
☐ GREASE TRAP	☐ C.B.'s/S		HOLDING	. *	
☐ PUMP CHAMBER	HYDRO D	DIGGING	TANK	25.5	
LOCATE/EXPOSE TANK	☐ SPECIAL	WASTE	FLUSH		
		Ž.	76 76		
UNIT # 14 RATE: _	FLAT HOU	RS @ PAT	PER HOUR	740	œ
	***	27 2 3	1973	4	
DISPOSAL FEE:	N/A LOAD	os @	PER LOAD	iX.	25.40
COMMENTS: FLUSH E	Kisistry Perin	retent 9%	Red Mr.	66	. Le
francise NORTH sid			Mark the first of the Parish State of the St	* g**	
oud not clean Ens			No.	•	1
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CHARGE	7	DRIVER IN	TIAL		4 3
2% INTEREST ON BALAN	ICE OVER 30 DAYS	Jum Dum	G.S.T.		



DEVELOPMENT SERVICES

15322 Buena Vista Avenue, White Rock, B.C. V4B 1Y6 Phone: (604) 541-2136 • Fax: (604) 541-2153

Inspection Report

NAME:		PERMIT No.:	1260
ADDRESS: 14034 W	larine	SHEET No.:	
			7/06
TYPE OF INSPECTION:			X 07
AREA OF INSPECTION:	spece Insi	ulation partial)
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		No.	100
		182/	
SIGNATURE:	INS	SPECTOR:	
DATE:	to		(*)

Please sign this form when the work is completed and return to the above department.



DEVELOPMENT SERVICES

15322 Buena Vista Avenue, White Rock, B.C. V4B 1Y6

Phone: (604) 541-2136 • Fax: (604) 541-2153

Inspection Report

NAME: _	Redacted S. 22	PERMIT No.: 08. 126
ADDRESS	: 14034 Marine Dr.	SHEET No.:
	INSPECTION:	DATE: Jan 23/09
AREA OF	INSPECTION: Ext Frame	
		ti
-	i) Metal brackets ragurad	on all not to bean
	CON CLOS	0 11 /20/ 1-1011
	2) Declaration letter required	from viny deck installer
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(2)	II NE	
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		746
9		
SIGNATUF	RE: INSPECTO	OR: XX
DATE:		

Please sign this form when the work is completed and return to the above department.



DEVELOPMENT SERVICES

15322 Buena Vista Avenue, White Rock, B.C. V4B 1Y6

Phone: (604) 541-2136 • Fax: (604) 541-2153

Inspection Report

NAME:	Redacted S. 22,	PERMIT No.: 08.126
ADDRESS: _	14034 Marine Dr. SPECTION: plumbing	SHEET No.:
TYPE OF INS	SPECTION: <u>olumbing</u>	DATE: 65 19/09
AREA OF INS	SPECTION: below Skb DWV	<u> </u>
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		1
SIGNATURE:	INSPECTO	



15322 Buena Vista Avenue, White Rock, B.C. V4B 1Y6 Telephone: (604) 541-2136 Fax: (604) 541-2153

Permit Number: 5495

APPLICATION FOR PLUMBING PERMIT

vner:_Red			94VI					W :-						* 8
ontractor:	OA M	EHAN	JICAL		Ph	one: <u>7</u> 7	8.90	8 3585	Business	Licence: Y	/es:N	o:/	Applied For:_	V_
vish to apply	to the Plur	nbing Insp	ector for a	permit to	install the	following f	fixtures:		15		**	8 N		8 % 2
Floor	Water Heater	Water Closets	Wash Basins	Bath Tubs	Showers	Kitchen Sink	Wash Tubs	Automatic Washer	Floor Drains	Urinals	Dish Washer	Hose Bibs	Sprinklers	Other Fixture
Basement		1				3			Ea	5 7	× 3 N	2	White v	1 8/
Main		2	2		20.1.11	1			201.0		v I		1 1	
Second			2				9		W				N.	
Third		ì					Wi _a					8 3	N.	
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Signature (Ap	plicant	7	3 1W - 1 - 2 - 3		······································				Signa	ture (Insp	ector)			0.00
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DEVELOPMENT SERVICES

15322 Buena Vista Avenue, White Rock, B.C. V4B 1Y6

Phone: (604) 541-2136 • Fax: (604) 541-2153

Inspection Report

NAME:	Redacted	S. 22	<u> </u>	PERMIT No.: _08	126
ADDRESS	14034	Marine I	ک د	SHEET No.:	_/
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SIGNATUR	E:		INSPECTOR		
DATE:		- 50 PM			9
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Please sign this form when the work is completed and return to the above department.

Water Pipe sizing for Single family Dwellings and Duplexes

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Bath tub =2			1		4				
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DEVELOPMENT SERVICES

15322 Buena Vista Avenue, White Rock, B.C. V4B 1Y6

Phone: (604) 541-2136 • Fax: (604) 541-2153

Inspection Report

NAME:Redacted S. 22	PERMIT No.: 08. 126
ADDRESS: 14034 Marina Dr.	SHEET No.:
TYPE OF INSPECTION:	DATE: NOV 27/08
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	e same a succession of success
	<u> </u>
SIGNATURE:	INSPECTOR:
DATE:	

Please sign this form when the work is completed and return to the above department.



Address: Unit 100-12099 237 81 Maple Ridge, 8C, V4R 2C3

Cell: 778.928.7589

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Address: Unit 100 12099 237.55 Maple Ridge, BC, V4R 2C3 Cell: 778.928.7589

Phone: 778.785.7729


To: Nova Developments	Date: 1/7 1/1 2008
From: Jorge Silva, P. Eng	
site: 14034 Marine Dr. Surrey	
Subject: Excavation Inspection Footing Inspection Other:	May and the second seco
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, Marine Dr	1
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# B.C. LAND SURVEYOR'S FORMS LOCATION CERTIFICATE OF: LOT A, SECTION 9, TOWNSHIP 1, NEW WESTMINSTER DISTRICT, PLAN 13312

(P.I.D. 001-763-440)


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ALL DISTANCES IN METRES

SCALE-1: 250

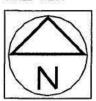

This document shows the relative location of the structures and features with respect to the boundaries of the parcel described above. It shall not be used to define property lines or property corners, and should be used in conjunction with a current title search to determine any charges which may affect land use.

LOT DIMENSIONS ARE FROM GROUND SURVEY BY MYSELF

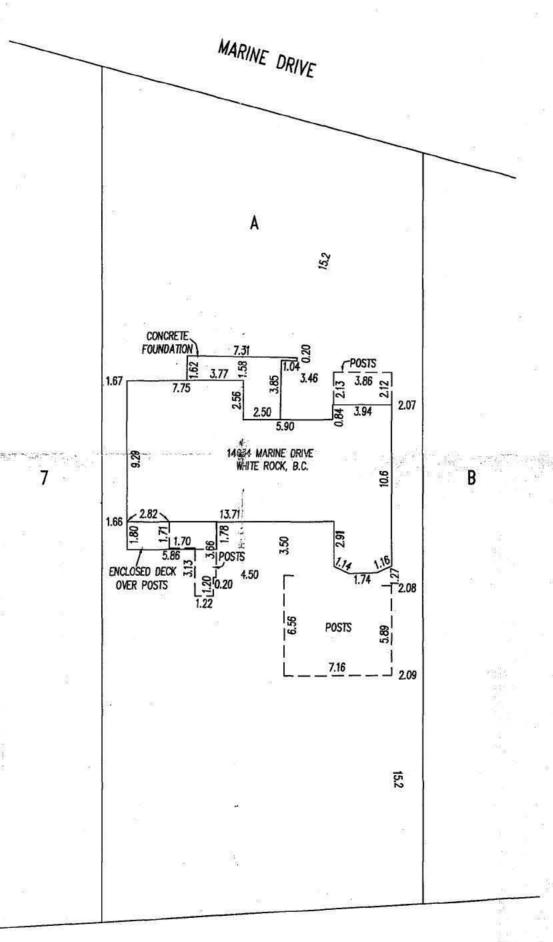

TERRY ROAD

This plan was prepared for municipal purposes and is for the exclusive use of our client.

All rights reserved. No person may copy, reproduce, transmit or after this document in whole or in part without the consent of the signatory.

The signatory accepts no responsibility or liability for any damages that may be suffered by a third party as a result of any decisions made, or actions taken

based on this document.

CERTIFIED CORRECT

Dated this 2/5t day of AOUTHEE. 2008
THIS DOCUMENT IS NOT VALID UNLESS
ORIGINALLY SIGNED AND SEALED. ©

FILE No. 17305FR-A OLSEN & ASSOCIATES BRITISH COLUMBIA LAND SURVEYORS 204-15585 24th AVENUE, SURREY, B.C. V4A 2J4 PHONE: 531-4067 Fax: 531-5811



# RECEIPT REPORT

1.	Name of who pa	id bond: Redacted S. 22	Address: 17057	MARINE BR., N.R.
2.	Site Address:		Phone: Redac	ted S. 22
3.	Date Paid: D	EC04/08 Clerk's Initial	B. Receipt # 10	0837
	BLDGPER	Building & Other Permits*	S	#
	BONDLAN	Landscaping Bond	S	\$V (9)
	BONDMIS	Miscellaneous Bond	s	
	BONDOCC	Occupancy Bond	s	
	BONDRD	Road & Right of Way Bond	<u> </u>	
	BONDSID	Sidewalk Café Bond	<u>s</u>	
	DCCGVSD	DCC's GVS & DD	s	
	DCCHWY	DCC's Highways & Roads	<b>S</b>	
	DCCPARK	DCC's Parkland	S	
	DCCSANIT	DCC's Sanitary Sewer	s	
	DCCSCHO	DCC's Surrey School District	s	
	DCCSTOR	DCC's Storm Drainage	s	
	DEMOPMT	Demolition Permit	s	#
	DEVPERMI	Rezoning/Development Permit	S	#
	DEVWKS	Development Works Reserve	<b>S</b>	
	PLUMBPE	Plumbing Permit	s	#
	RESTRICT	Restrictive Covenant	s	
	REZONIN	Rezon./Dev. Permit Adv.Revenue	e \$	#
	RDRWINSP	Road & Right of Way Permit	S	#
	SANITCAP	Sanitary Sewer Cap Fee	\$	
	SANITCF	Sanitary Sewer Connection Fee	s 1,250	
	SECSUITE	Registration Fee	S	
	SERVAGRE	Service Agmt Admin. Fee	S	
	SIGNPER	Sign Permit	s	# # # # # # # # # # # # # # # # # # # #
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3.	7.00	lov 7/08 Clerk's Initial	Receipt #	1 100340
	BLDGPER	Building & Other Permits*	\$	1_100340
	BONDLAN	Landscaping Bond	<u>s</u>	
	BONDMIS	Miscellaneous Bond	<b>s</b>	
0/	BONDOCC	Occupancy Bond	\$	
W	BONDRD	Road & Right of Way Bond	s 2,500	
	BONDSID	Sidewalk Café Bond	\$	
0	DCCGVSD	DCC's GVS & DD	\$	
L1	DCCHWY	DCC's Highways & Roads	<u> </u>	
	DCCPARK	DCC's Parkland	S	
	DCCSANIT	DCC's Sanitary Sewer	S	• 46 PERSON
	DCCSCHO	DCC's Surrey School District	s	
	DCCSTOR	DCC's Storm Drainage	s	
	DEMOPMT	Demolition Permit	S	#
0	DEVPERMI	Rezoning/Development Permit	s	#
	DEVWKS	Development Works Reserve	s	
	PLUMBPE	Plumbing Permit	s	#
	RESTRICT	Restrictive Covenant	s	
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	SANITCAP	Sanitary Sewer Cap Fee	<u> </u>	
D	SANITCF	Sanitary Sewer Connection Fee	\$	
	SECSUITE	Registration Fee	\$	
	SERVAGRE	Service Agmt Admin. Fee	\$	
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a	STORMCA	Storm Sewer Cap Fee	\$	
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			· OFF	

### *Includes Hoarding & Shoring fees

Lines 1. & 3. to be filled in by person entering transaction into till. Line 2. by Plan Checker or Planner.

K:\PROPERTY\WORDDOCS\RECEIPTS\Receipt Form.doc

Rvsd Sept.30, 2005

MS BONDRD

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Nov/2008 CARMEL



# THE CORPORATION OF THE CITY OF WHITE ROCK 15322 BUENA VISTA AVENUE, WHITE ROCK, B.C. V4B 1Y6

DEVELOPMENT SERVICES DEPARTMENT TEL: (604)541-2136 FAX: (604)541-2153

# **BUILDING PERMIT INFORMATION SHEET**

Civic Address: 14034	MARINE DE	2IVE	Zoning: 1	34_
Legal Description: LOTA	, 1036, 556.9,	TWP/, NH	D NEA,	PLON 13312
Site Statistics: Lot Area:	12167 Squ	are Feet	5	2
Lot Coverage: (Building footprint Including Any detached Structure)	Permitted: 547 Percentage: 45	S⊭ Prop % Pero	oosed: S entage 2	034
Setbacks: Permitted: Proposed:	North 7.5 South	h <u>7.5</u> Eas h <u>15.2</u> Eas	t <u>1.5</u> Wes t <u>2.07</u> Wes	t 1.5
Building Statistics:	3 20 6 71 8 7 8	e 10 10	80 - 12 21 21	
Basement Floor Main Floor Upper Floor Registered suite Garage Other/Additions	Squi	are Feet are Feet are Feet		on)=23.6%
Residential Gross Floor Area:	Permitted: 50		osed: <u>24</u> centage	
Driveway Slope:	Permitted: 15%	Pr	oposed: EX	STING. %
Owner Builder Declaration	& Disclosure Notice	Ye	S 🗆	No 7Q
Third Party Home Warranty - Name of Provider:		Ye	s 🗆 💮	No 🕱
Builder's Business License	Number:			# W
Board of Variance granted	er e	Ye	s o	No 📶
Spatial Calculation include	<b>d:</b> =	Ye	os 🗆	No 🗹
Property Adjacent to Water	Course or Ravine:	Ye	s 🗆	No 🗷
Property falls within the Tr	ee Management By-L	.aw: Ye	es 🗆	No 🗆
<b>,</b>	51h.	certifiy this ii	nformation to	be correct.
Signature:	3	Date		

#### TOPOGRAPHIC PLAN OF LOT A, SECTION 9, TOWNSHIP 1, NEW WESTMINSTER DISTRICT, PLAN 13312 (P.I.D. 001-763-440) ALL DISTANCES IN METRES SCALE-1: 250 68.20 MARINE DRIVE GUTTERLINE 67.58 61.6h . This document shows the relative location of the structures and features with 105'00'45" respect to the boundaries of 22.086 the parcel described above. It shall not be used to define property lines or property corners, and should be used in conjunction with a current title search to determine any charges which may affect land use. 20.30 LOT DIMENSIONS ARE FROM 17.17 GROUND SURVEY BY MYSELF GROUND ELEVATIONS ON THIS PLAN ARE DEEMED TO BE NATURAL GRADE. THIS PLAN DOES NOT CONSTITUTE A RESURVEY OF THE LEGAL BOUNDARIES OF THE TITLED LOT OR LOTS, IT IS 1.67 PEAK . 7.75 COMPILED FROM FIELD TIES AND 2.56 ELEV.=71.70 LAND TITLE OFFICE RECORDS. 2.07 MAIN FLOORJ 5.90 65.88 SLAB! ELEV.=67.55 ELEV.=66.44 В BASEMENT FLOOR **ENCLOSED** (ELEV.=64.93 13.71 DECK 79.55.50 1.66 DECK 7.85 64.83 DECK OVER 2 OPEN CARPORT 5.28 2.08 15.1 SIM 65 KJ 21.380 61,87 6134 6193 62,12 STM MH GUTTERLINE LEGEND SAN MH (2) STM MH → STORM MANHOLE CENTERLINE OF TRAVELLED PORTION SAN MH * SANITARY MANHOLE 62.18 65/8 NOTE - GROUND ELEVATIONS ON THIS PLAN ARE NOT TO BE USED FOR CONSTRUCTION BENCHMARK PURPOSES. TERRY ROAD A BENCHMARK MAY BE OBTAINED FROM THIS OFFICE. INDICATES LOCATION AND THIS PLAN WAS PREPARED FOR MUNICIPAL PURPOSES ELEVATION OF GROUND SHOT. CERTIFIED CORRECT AND IS FOR THE EXCLUSIVE USE OF OUR CLIENT. ALL RIGHTS RESERVED. NO PERSON MAY COPY, REPRODUCE, TRANSMIT OR ALTER THIS DOCUMENT IN WHOLE OR IN PART WITHOUT THE CONSENT OF THE SIGNATORY. ELEVATIONS ON THIS PLAN ARE DERIVED THE SIGNATORY ACCEPTS NO RESPONSIBILITY OR LIABILITY FOR FROM CITY OF WHITE ROCK BENCHMARK #88H3898

FILE No. 17305T

BASED ON THIS DOCUMENT.

ANY DAMAGES THAT MAY BE SUFFERED BY A THIRD PARTY

AS A RESULT OF ANY DECISIONS MADE, OR ACTIONS TAKEN

OLSEN & ASSOCIATES BRITISH COLUMBIA LAND SURVEYORS


204-15585 24th AVENUE, SURREY, B.C. V4A 2J4

LOCATED AT 140th ST. AND MARINE DRIVE.

PHONE: 531-4067

THIS DOCUMENT IS NOT VALID UNLESS

ORIGINALLY SIGNED AND SEALED.

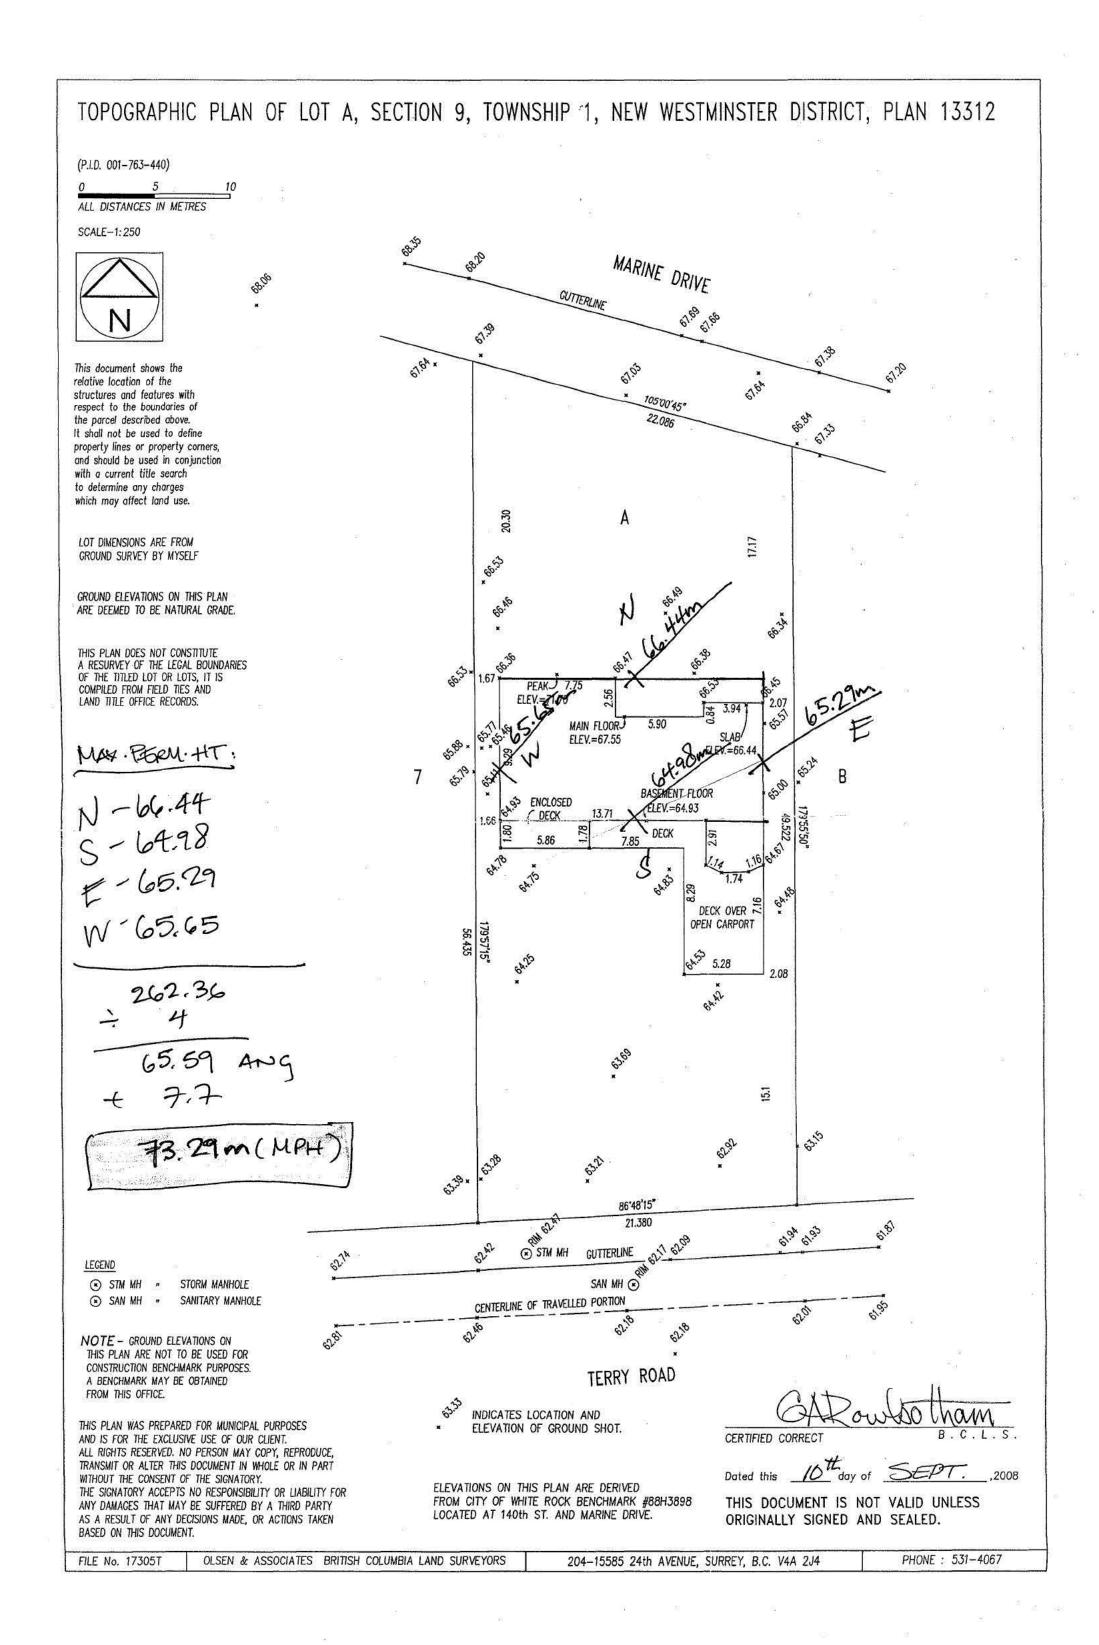



15322 BUENA VISTA AVENUE, WHITE ROCK, B.C. V4B 1Y6 Pone: 604-541-2136 Fax: 604-541-2153

### APPLICATION FOR BUILDING PERMIT

Date: 607.27/08	3.	47
	X	By-Law" and amendments thereto, for permission to
(Сору	of Plans of Proposed Building of	or Alteration to Accompany this Application)
zoning: RS-4-	\$	Development Permit #
Legal Description: LoT A	·, 8EC9,	TPI, NWD, PLAN 13312
Project Civic Address: 140	34 MARINI	EDR.
Survey Plan required	No 🗆	Yes N
Are there any buildings already occ		
What are they, and what are they u	sed for? PRINC	UPAL PERIOTICE-
Entire value, when completed \$	300,000	
@	# 2	# %
Name and address of owner Re	dacted S. 22	. D. J
Redacted S. 22		Phone: Redacted S. 22
Name and address of builder O	NNER/BUIL	· ·
SAME AS ABOVE	7.	Phone:
Name of project architect / engine		
Roll No. 310.000	Signature of Ap	Redacted S. 22
Building Permit Fee: 4838	And I agree to	conform to all requirements of said By-Law.
Permit No: 08126	2,393 25	The approval of the plans and the issuance of a permit shall not in any way relieve the owner of any building or structure from full responsibility for carrying out the work or having the work carried out in accordance with the requirements of all the applicable by-laws of the Corporation of the City of White Rock.

MS BLDGPER

2788.25

MS COPIES

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otal :

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VISA

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R:100081 / B:2008102701 / D:2007 27/

Oct/2008 LORI



15322 BUENA VISTA AVENUE, WHITE ROCK, B.C. V4B 1Y6

DEVELOPMENT SERVICES DEPARTMENT TEL: (604)541-2136 FAX: (604)541-2153

# FORM 'B'

### PROOF OF PROFESSIONAL LIABILITY INSURANCE

RE: Address: 14034 Marine Drive, White Rock

Building Permit Application No.:	
The undersigned hereby gives assurance that	t: "
	ain a subsisting policy of professional liability as outlined in section 16.3 of Building Bylaw
<ul> <li>b) I have enclosed a copy of my certification such coverage.</li> </ul>	icate of insurance indicating the particulars of
<ul> <li>c) I am a registered professional as de Columbia Building Code.</li> </ul>	efined under Section 1.1.3.2. of the British
<ul> <li>d) I will notify the Building Official immediately expired or terminated at any time d</li> </ul>	ediately if this insurance coverage is reduced, uring construction.
Signed this 23 day of October.	Jorge Silva G Print Name of Registered Professional
e e e e e e e e e e e e e e e e e e e	Signature of Registered Professional Structural & Geotechnical
	Professional's Discipline
	Professional's seal  J. E. SILVA GUTIERREZ  # 32026  C. BRITISH  C. L. I. M.
Signed this 27 day of October.	Redacted S. 22
72 8	wimess Signature



ENCON Group Inc.
500 - 1400 Blair Place
Ottawa, Ontario K17 9B8
Telephone 613-786-2000
Facsimile 613-786-2001
Toll Free 800-267-6684
www.encon.ca



# Binder Architects & Engineers Professional Liability Insurance

23 July 2008

PARK INSURANCE AGENCY LTD. 420-4400 DOMINION ST BURNABY, BC V5G 4G3

Attention: CATHY MCRAE

Re: CORNERSTONE GEO-STRUCTURAL

ENGINEERING LTD.

Customer No. 246843

New Certificate No. ENG345704

As requested, we have bound coverage effective 22 July 2008 to 22 July 2009. Limits are as follows:

LIMIT	AGGREGATE LIMIT	DEDUCTIBLE	PREMIUM
\$500,000	\$1,000,000	\$2,000	\$4 185

SCHEDULE OF INSURERS:	Subscribing Insurer(s)	Percenta	ge
	Continental Casualty Company (CNA)	37.0	%
	XL Reinsurance America Inc.	25.0	%
	Temple Insurance Company	23.0	%
	Aviva Insurance Company of Canada	7.5	%
	Certain Underwriters at Lloyd's	7.5	%
	under Agreement No. ENC108-09		

We are binding based on the terms and conditions set out in our quote letter of 24 June 2008. The documents will follow shortly.

#### **SCHEDULE B-1**

Forming Part of Subsection 2.2.7, Div. C of the British Columbia Building Code Building Permit No.1

# ASSURANCE OF PROFESSIONAL DESIGN AND COMMITMENT FOR FIELD REVIEW

Notes: (i) This letter must be submitted along with Schedule B-2 before issuance of a building permit. A separate letter must be submitted by each registered professional.

(ii) This letter is endorsed by: Architectural Institute of BC, Association of Professional Engineers and Geoscientists of BC, Building Officials' Association of BC, and Union of BC Municipalities.

(iii) In this letter the words in italics have the same meaning as in the British Columbia Building Code.

To: The	authority	having	jurisdiction
---------	-----------	--------	--------------

#### City of White Rock

Name of Jurisdiction (Print)

Re: Proposed house addition-review existing house

Name of Project (Print)

14034 Marine Dr

Address of Project (Print)

Lot A, LD36, Sec9, TWP1, NWD NE1/4, Plan 13312

Legal Description of Project (Print)

The undersigned hereby gives assurance that the design of the

(Initial those of the items listed below that apply to this registered and the disciplines will not necessarily be employed on every project.)

ARCHITECTURAL

SIKUCTUKAL

MECHANICAL PLUMBING \

FIRE SUPPRESSION SYSTEMS

ELECTRICAL

GEOTECHNICAL — temporary

GEOTECHNICAL — permanent

components of the plans and supporting documents prepared by this *registered professional* in support of the application for the *building* permit as outlined on the attached Schedule B-2 substantially comply with the BC Building Code and other applicable enactments respecting safety except for construction safety aspects.

The undersigned hereby undertakes to be responsible for *field reviews* of the above referenced components during construction as indicated on the attached "SUMMARY OF DESIGN AND FIELD REVIEW REQUIREMENTS" (SCHEDULE B-2).

CRP's Initials

Date

10/22/2008

1 For authority having jurisdiction's use only

1 of 2

#### THE CORPORATION OF THE

### CITY OF WHITE ROCK

15322 BUENA VISTA AVENUE, WHITE ROCK, B.C. V4B 1Y6

DEVELOPMENT SERVICES DEPARTMENT TEL: (604)541-2136 FAX: (604)541-2153

### BUILDING PERMIT APPLICATION REQUIREMENTS FOR SINGLE FAMILY DWELLINGS

Home Owner's Protection Form – For new homes only (Contact Homeowners Protection Office (HPO) at 604.646.7050) Authorization Form (if applicant is not owner) Title Search - dated within the last thirty (30) days (see reverse for more information on how to obtain) Topographical Survey (Original drawing signed and sealed by a BC Land Surveyor) Underpinning/Shotcrete Legal Agreement (from adjacent property owners -Notarized by Notary Public or Lawyer) Form A – "Owner's Acknowledgement of Responsibility & Undertakings" (Original Form A signed by owner) Form B – "Proof of Professional Liability Insurance (Original Form B signed and sealed required from all engineers) **Building Permit Information Sheet** (completed by designer) Two (2) Sets of Drawings (To Scale: 1/2"=1'-0") (Drawing requirements can be found on-line in our Building By-laws #1782 - City website www.city.whiterock.bc.ca) Driveway Section Detail (Site plan to show proposed driveway slope percentage (%) - Max. permitted slope is 15%) Structural & Geotechnical Engineered Drawings and Schedules B1 & B2 (Originals signed and sealed required) Building Envelope Engineer- Details & Schedules B1 & B2 (2 sets of Original details signed and sealed required) Two (2) sets of Engineered Sprinkler Drawings and Hydraulic calculations c/w original Schedules B1 & B2* (By sprinkler engineer) * As of January, 2003 EPCOR White Rock Water Serviceability Form - Original signed copy required (form completed by homeowner and signed by EPCOR White Rock Water - See back for contact info.) wher is required to confirm depth of sewer services. Contact Engineering Dept.

at (604) 541-2181 to find out if a storm sewer pump will be required.

already pumping

### To obtain a Title Search for your property, you can:

- Go to Land Title Office located at #300 88 6th Street, New Westminster, BC, V3L 5B3 (Tel: 604.660.8141) and bring with you the Legal Description of the property in question or the PID number. The cost is \$9.50
- Mail the information, including payment and a copy will be sent to you by mail.
- Have your Lawyer or Notary obtain a copy on your behalf or
- Have an Agent for Lawyer obtain a copy.

### **Additional Contact Information:**

### **EPCOR White Rock Water:**

Unit 102 – 1440 George Street White Rock, B.C., V4B 4A3 604.536.6112

### **BC** Assessment Authority:

#208 – 5460 152nd Street Surrey, BC, V3S 5J9 604.576.4700

### **Homeowner Protection Office:**

PO Box 11132 Royal Avenue Suite 2270 – 1055 W. Georgia St. Vancouver, BC, V6E 3P3 604.646.7050

### **Enquiry BC:**

Vancouver 604.660.7867

Schedule B-1 - Continued	
	Building Permit No. ¹ 14034 Marine Dr
	Project Address
	Geotechnical & Structural
	Discipline
The undersigned also undertakes to notify the authority havi undersigned's contract for field review is terminated at any ti certify that I am a registered professional as defined in the	ime during construction.
Jorge Silva	
Registered Professional's Name (Print)	
#100 12099 237th St	
Address (Print) Maple Ridge, BC, V4R 2C3	AL PRESSION AND AND AND AND AND AND AND AND AND AN
(778) 928-7589	Tras top of the state of the st
If the Registered Professional is a member of a firm, complete am a member of the firm. Cornerstone Geo-Structural Earnd I sign this letter on behalf of the firm.  Note: The above letter must be signed by a registered professional to mean  (a) a person who is registered or licensed to practise	Engineering Limited (Print name of firm) ssional. The British Columbia Building Code defines a
Geoscientists Act.	
For authority having jurisdiction's use only 2 of 2	CRP's Initials

î

	SCHEDULE B-2	
	Forming Part of Subsection 2.2.7, Division C of the Building Permit British Columbia Building Code	No.1
	SUMMARY OF DESIGN AND FIELD REVIEW REQUIREMENTS	
Notes	s: (i) This letter must be submitted along with Schedule B-1 before issuance of a building permit.  (ii) This letter is endorsed by: Architectural Institute of BC, Association of Professional Engineers and Geoscientists of BC, Building Officials' Association of BC, and Union of BC Municipalities.  (iii) In this letter the words in italics have the same meaning as in the British Columbia Building Code.	
Regis	istered Professional's Name (Print) Jorge Silva	Value (III)
Name	e of Project (Print) Proposed house addition-review existing house	
Addre	ress of Project (Print) 14034 Marine Dr	<del></del>
	al applicable discipline below and cross out and initial only those items not icable to the project.)	
V000000	ARCHITECTURAL	1
	Fire resisting assemblies	1
	Fire separations and their continuity	
	Closures, including tightness and operation	1
	Egress systems, including access to exit within suites and floor areas Performance and physical safety features (guardraiks, handrails, etc.)	1
1.6	Structural capacity of architectural components, including anchorage	1
	and seismic cestraint	1
	Sound control	
1.8	Landscaping, screening and site grading	
1.9	Provisions for fire fighting access	1
	Access requirements for persons with disabilities  (Professional's Seal and Signature)	-
1.11	Elevating devices Functional testing of architecturally related fire emergency systems  (Professional Seal and Signature Functional testing of architecturally related fire emergency systems	e)
	and devices	
1.13	Development Permit and conditions therein Interior signage, including acceptable materials, dimensions and	Dete
	locations TO MILE	Date
1.15	Review of all amplicable shop drawings	
1.16	Interior and exterior finishes	
	Dampprofing and/or waterproofing of walls and slabs below grade Roofing and flashings	
	Wall cladding systems	
	Thermal insulation systems, including condensation control and	
	cavity ventilation	
	Exterior glazing	
	Integration of building envelope components Environmental separation requirements (Part 5)	
'LL		
Y	STRUCTURAL	
	Structural capacity of structural components of the <i>building</i> , including anchorage and seismic restraint Structural aspects of deep foundations	
	Review of all applicable shop drawings	
	Structural aspects of unbonded post-tensioned concrete design and construction	
	MECHANICAL	
3.1	HVAC systems and devices, including high building requirements where applicable	
	Fire dampers at required fire separations	
	Continuity of fire separations at HVAC penetrations	
	Functional testing of mechanically related fire emergency systems and devices	
	Maintenance manuals for mechanical systems	
	Structural capacity of mechanical components, including anchorage and seismic restraint Review of all applicable shop drawings	
J.1	Menen of all applicable only drawings	
-		
' For a	authority having jurisdiction's use only  CRP's Ini	inle
	CRP's Ini	Idis
	1 of 2	

UU	edule B-2 - Continued  Building Permit No.
	Address of Project (Print) 14034 Marine Dr
	Registered Professional's Name (Print) Jorge Silva
1	PLUMBING Roof drainage systems
2	Site and foundation drainage systems
3	Plumbing systems and devices
4	Continuity of fire separations at plumbing penetrations
5	Functional testing of plumbing related fire emergency systems and devices
6	Maintenance manuals for plumbing systems
7	Structural capacity of plumbing components, including anchorage
	and seismic restraint
8	Review of all applicable shop drawings
	FIRE SUPPRESSION SYSTEMS
.1	Suppression system classification for type of occupancy
2	Design coverage, including concealed or special areas
	Compatibility and location of electrical supervision, ancillary alarm
1000	and control devices
4	Evaluation of the capacity of city (municipal) water supply versus
	system demands and domestic demand, including
_	pumping devices where necessary
5	
6	Review of all applicable shop drawings
7	Acceptance testing for "Contractor's Material and Test Certificate"
٥	as per NFPA Standards (Professional's Seal and Signature)
8	Maintenance program and manual for suppression systems Structural capacity of sprinkler components, including anchorage
9	and seismic restraint
10	For partial systems - Confirm sprinklers are installed in all areas
. 10	where required
11	Fire Department connections and hydrant locations
12	Fire hose standpipes 1
13	Functional testing of fire suppression systems and devices
	ELECTRICAL
1	Electrical systems and devices, including high building requirements where applicable
2	Continuity of fire separations at electrical penetrations
	Functional testing of electrical related fire emergency systems and devices
4/	Electrical systems and devices maintenance manuals
8	Structural capacity of electrical components, including anchorage and seismic restraint
	Clearances from buildings of all electrical utility equipment
7	Fire protection of wiring for emergency systems
۴۱	Review of all applicable shop drawings
H	GEOTECHNICAL — Temporary
7	Excavation
¥ _	Shering>
3	Underpinning
¥	Temporary construction dewatering
Ð	GEOTECHNICAL — Permanent
1	Bearing capacity of the soil
2	Geotechnical aspects of deep foundations
	Compaction of engineered fill
	Structural considerations of soll, including slope stability and seismic loading
	Backfill
6 _	Permanent dewatering
	Permanent underpinning
<u> </u>	CRP's Initials
or e	authority having jurisdiction's use only



15322 BUENA VISTA AVENUE, WHITE ROCK, B.C. V4B 1Y6

DEVELOPMENT SERVICES DEPARTMENT TEL: (604)541-2136 FAX: (604)541-2153

### FORM 'A'

### OWNERS ACKNOWLEDGEMENT OF RESPONSIBILITY AND UNDERTAKINGS

RE:	Address: 14034 Marine Drive  Building Permit Application No.:				
1.	I am the owner of the land and premises located at Ho34 Marine Drive WHITE ROCK BC.				
2.	I understand and acknowledge that I am fully responsible for carrying out the work or having the work carried out, in accordance with the requirements of the <i>British Columbia Building Code</i> , the <i>Building Bylaw No</i> . 1782 and all other bylaws of the City of White Rock.				
3.	I will comply with, or cause those whom I employ to comply with the <b>British Columbia Building Code</b> and all bylaws of the City of White Rock and other statutes and regulations relating to the development, work, undertaking or permission in respect of which this application is made.				
4.	I understand and acknowledge that neither the issuance of a permit under <b>Building Bylaw No.</b> 1782, the review of plans and supporting documents, nor inspections by a building official shall, in any way, constitute a representation, warranty, or statement that the <b>British Columbia Building Code</b> , <b>Building Bylaw No.</b> 1782, or any other bylaw of the City of White Rock has been complied with.				
5.	If the material submitted in support of the application for this Building Permit included certification provided by Registered Professionals in the form of Schedules B-1 and B-2 referred in section 2.6 of Part 2 of the <i>British Columbia Building Code</i> , I understand and acknowledge that the City of White Rock and its building officials				
R 8	have relied on those letters of assurance as certification that the design and plans to which they relate comply with the <b>British Columbia Building Code</b> and other applicable enactments relating to safety.				

- In particular, I understand and acknowledge that the City of White Rock has relied on the letters of "Assurance of Professional Design and Commitment for Field Review" provided by:
  - * Insert the name of the Registered Professionals where applicable below:

	Architectural:	
# N .	Building Envelope:	
:B	Structural: Jorge Silva G	
973 51	Mechanical:	·
±:  €	Plumbing:	
	Fire Suppression Systems:	
	Electrical:	
	Geotechnical: Jorge Silva G	Land of the second of the seco
22		documentation submitted with this application
7.	I am authorized to make this acknowled undertakings to the City of White Rock	edgement of responsibility and give these
8.	respect to the responsibilities I am ass	or me to seek independent legal advice with uming upon the granting of a Building Permit this application and in respect of the execution
Signe	ed this 37 day of October/08	Redacted S. 22 Print Name
		Redacted S. 22
* o	HE AN MARKET BY	Signature or owner (or signing officer if the owner is a
	* **	corporation)
Signe	ed this 37 day of Totaler OP.	Withess Hall
9		Diveloper Occupation



## City of White Rock - Public Works Department Storm & Sanitary Sewer Connection Sheet



Address:	14034 Mari	ne Drive Contractor:		
Legal Description:	Lot A, Plan	13312, Part NE1/4, Section 9, Township 1, Nev	V	
	Westminste	er Land District		
Owner's Name:	Redacted S. 2	22 Phone #: Redacted	S. 22	
Date Filed:		Date Paid:		
Date Installed:	Resident to	meet with PW Foreman to schedule installatio	n.	
Sanitary Sewer Service	*Depth an	d Location are approximate and to be used as a guide only		
Proposed Location:	100mm	PVC service to be installed (w/IC) off the South	end of the	
	property	y. Foreman to discuss location with resident. Re	esident will	
	T (1000) 1000	grade with tie-in to the Terry Road main.		
Approximate Depth:		etermined.		
Main Extension Required	i: Yes	No 🖂		
Remarks:	Residen	t will need to cap existing connection at Marine	Drive	
ter remaining placement statements in a		oreman to discuss with resident). This fee will r		
		1,250.00 depending on the material of the conn		
Cap-Off Fee		(\$25.00 if not collected at time of Demo Permit)	\$0.00	
Connection Fee		(\$1,200.00)	\$1,200.00	
Inspection Fee		(\$50.00)	\$50.00	
Cap-Off at Main (Marine		(To be determined during cap-off/installation)	TBD	
EXPORT MATERIAL PRODUCTION OF THE SECOND SEC	The state of the s	Can be paid at a later date.		
Total Cost for Sanitary C			\$1,250.00-	
Storm Sewer Service	*Depth an	d Location are approximate and to be used as a guide only		
Existing Location:	10' East	10' East of Southwest corner of the property.		
Approximate Depth:	2'			
Main Extension Required	l: Yes	No 🏻		
Remarks: IC installation required for this property.				
Cap-Off Fee		(\$25.00 if not collected at time of Demo Permit	\$0.00	
I/C Installation Fee		(\$350.00)	\$350.00	
Inspection Fee		(\$50.00)	\$50.00	
Total Cost for Storm Con			\$350.00	
Total Cost For Storm &	Sanitary So	ervices	\$1,600.00-	
		tor must complete a "City Road & ROW Permit" for City E posed works that cross City Boulevard.	ngineer's	

Maximum Allowable Driveway Grade:

15%

Proposed Driveway Grade:

Remarks:

#### **General Requirements**

- IF THE ABOVE LOCATION OF THE NEW SERVICE IS NOT WHERE THE OWNER / BUILDER WOULD LIKE THEY MUST REQUEST A NEW LOCATION THROUGH PUBLIC WORKS AND AN ADDITIONAL FEE WILL BE REQUIRED
- Owner / Builder must expose existing sanitary service at the property line for Cap-Off by Public Works Foreman. Failure to do so will result in denial for request of a Building Permit.
- All work must conform to the City of White Rock Standards and Specifications
- All inspections on private property to be carried out by the City's Building Department
- The owner / builder is responsible for maintaining and lowering the Inspection Chamber to no lower than finished grade. Any replacement / repairs to the Inspection Chamber must be done by the City and the costs will be charged to the owner.
- All services will be installed at the lowest possible elevation, however, the City is not responsible for providing a gravity service. It is the owner's / builder's responsibility to connect at that elevation at property line whether by gravity or sump pump
- Notify Public Works Foreman (541-2181) two weeks prior to service installation to allow for scheduling of work

Date:	DEC 0 4 2008	Applicant's Signature:	Keuacteu	3. 22
¥2 <del></del>		<b>→</b> 0 1554-51		

### SCHEDULE 'C' City Road and Right of Way Use Permit

BUILDING PERMIT NO. 08-543

Effective:

November 07, 2008

Expiry:

November 07, 2009

OWNER

edacted S. 22

14034 Marine Drive Address:

Telephone Numbers

14034 Marine Drive

BUILDER Name:

Address:

LOCATION OF WORK: 14034 Mari PERMISSION IS HEREBY GRANTED TO:

Telephone Numbers:

Redacted S. 22

Protection of City Boulevard During Renovation Construction:

Boulevard restoration must be completed to meet the following requirements prior to the refund of the \$2,500 Security Bond:

- Driveway access through the City Boulevard must be restored according to the current City of White Rock Street and traffic Bylaw.
- Driveway access to be asphalt or brick pavers from property line to road edge.
- Driveway access must slope up at 2% from road edge to property line before sloping to garage slab at maximum 15%.
- Backfill under driveway within the City Boulevard must be structural fill (3"minus free draining granular material).
- Remaining City Boulevard (property line to road edge) must be restored with a minimum 150mm of topsoil and sod or landscaping ground cover approved by the Parks Manager (604-541-2181).
- No "landscape rock" is permitted on the City Boulevard.

All works shall be completed in accordance with all current City of White Rock construction specifications and standard drawings. The applicant shall not employ a contractor not skilled in the work assigned. An as-built drawing may be required with the attached specifications prior to release of security deposit. The following City inspections are required to satisfy the terms of this permit:

#### Road and Boulevard

To schedule an inspection, please call the Municipal Operations Department at 604-541-2181. Please note that a charge of \$50.00 shall be paid by the owner for each additional inspection made not mentioned above.

I hereby agree to all the terms of the Highways Use By-law which pertain to this permit and deposit wherewith the some to guarantee the fulfillment of the terms of and within the time specified for the permit. A refund of the security deposit will be issued upon successful completion of this work and if required a submission and acceptance of an as-built drawing (and after all City inspections are passed) minus any additional cost incurred by the City of White Rock. I further agree to indemnify and save the City harmless against any and all claims, actions or expenses whatsoever or by whomsoever brought against the City by reason of the City granting me Use Permit or by reason of the construction of the above referred Re

			33		
APPI	TCA	NTS	SICN	ATI	DE

DATE

ISSUED BY:

**Engineering Department** 

NDV 07 2008

FEES

ROW Security Bond

Permit

\$2,500.00 \$50.00

TOTAL

\$2,550.00

DEPOSIT RECEIPT NO.

### Carolyne Leveille

From:

Paul Stanton

Sent:

Monday, April 06, 2009 10:56 AM

To:

Alan Markovic

Cc:

David Pollock; Carolyne Leveille; Guy Gareau

Subject: RE: Request for action 4034 MARINE DR

I meant to discuss this item at our meeting last Thursday, but it slipped my mind at the time. I did review our Building Bylaw as well as our Street and Traffic Bylaw, then discussed the issue with Peggy. Peggy and I both shared the concern that an existing property that already has the two entrances is protected by section 911 of the Local Government Act. Even though the building permit is resulting in the complete retro fit plus addition to the existing dwelling, it is still not intensifying the use i.e. it will still be a single family dwelling when complete. This property already has the two entrances, which is different from the situation a couple of doors down where they only have the one entrance, and the Street and Traffic Bylaw prevents the 2nd entrance only because Terry Road is wider than a lane (even though it's narrower than a normal sized road ROW as a 40 foot wide ROW).

From: amarkovic@city.whiterock.bc.ca [mailto:amarkovic@city.whiterock.bc.ca]

Sent: Friday, March 27, 2009 1:35 PM

To: Paul Stanton

Subject: Request for action - 14034 MARINE DR

Hi: Paul

s. 22 at 14034 MARINE DR called on 2009-03-27

Telephone Number: Redacted S. 22 Celiphone Number: Redacted S. 22 Inquiry Type: Road Allowances

Action Requested:

History

Comments:

Hello s. 22 As discussed yesterday, a ROW permit will be required at this property to address the concerns of 1. Two driveway accesses which are not permitted under the Street and Traffic Bylaw, although prior to the renovation two did exist along with two letdowns off of Terry Road and Marine Drive, 2. One access should be removed, presumably off of Marine as the garage is located off of Terry, 3. A plan which will show the proposed access off of Terry road with widths and slopes in conformance with the Street and Traffic Bylaw, 4. The type of materials proposed for re-instating one of these driveways. I have attached the original permit submitted by the Operations Department when this project was deemed a reno less than 50%, as well as the boulevard improvement application subbmitted to remove the juniper/cottoneaster hedge on City property. From inspection performed at this point, it was noted that both d/w accesses were in the process of being re-done without permit. Attached is also a quote from Paul to remove the Marine Driveway letdown and the placment of a barrier curb and sidewalk. Also attached is comments from our Arborist as to the planting plan submitted for permit and the ROW permit drafted for this purpose. AM

Additional Notes:

** Click on the ADDRESS link to bring up the map. Click here to enter the COMPLETION DATE after the job is done.

## AAA PYRAMID TRUSS

33771 MOREY AVE. ABBOTSFORD B.C. V2S 2W5 BUS: (604) 854-6626 FAX: (604) 854-6614 work # 2020

1


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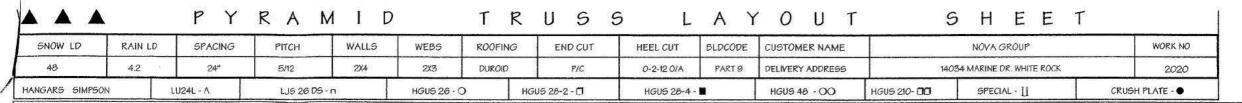
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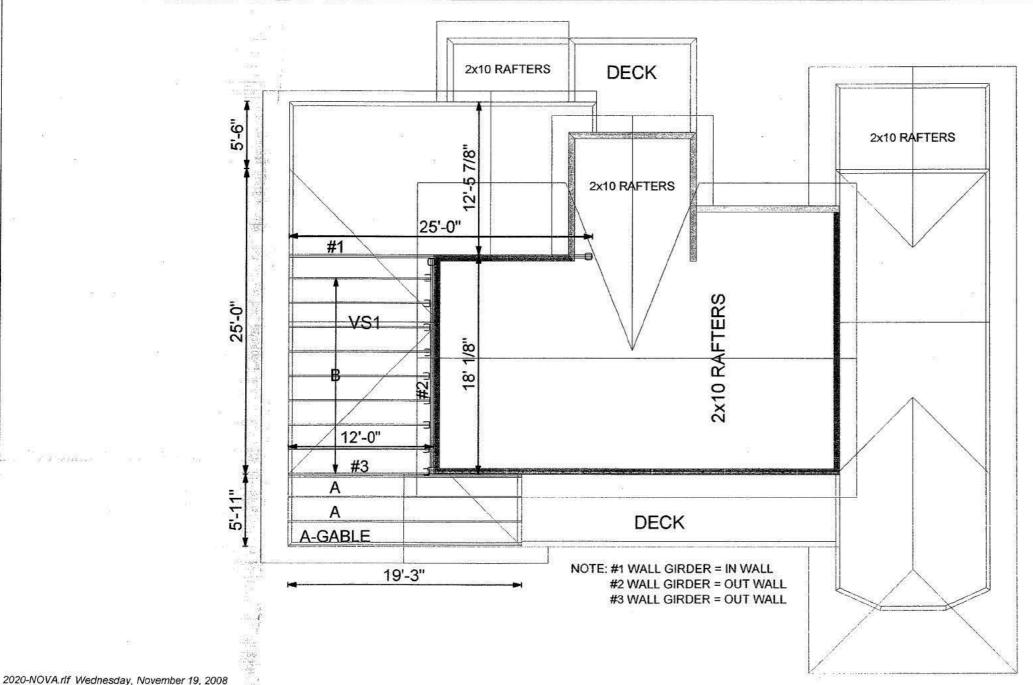
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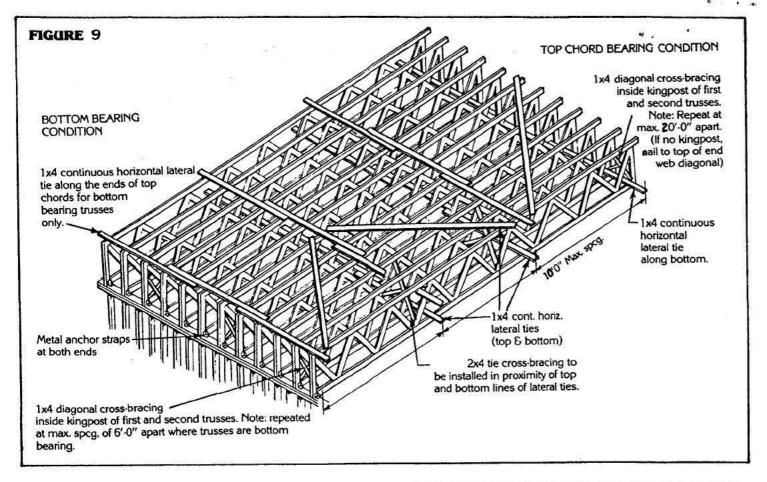
CUSTOMER		NOV	/A GROUP	DELIVE	DELIVERED TO 14034 MARINE DR. WH						CK		
BUS /	RES	2	Salaran Salara		DE	ELIVERY	DATE		TRUCK REQUIRED				
CELL		604	-308-6261	TRS	NO	7. 21/08		TRS	PYRAMID				
FAX	- 1 - 1 - 1 - 1 - 1 - 1 - 1 - 1 - 1 - 1	1		WG	WG				WG				
DATE (	QUOTED		VIII	SNOWLO	DAD	48 RA		RAIN	LOAD	OAD 4.2		BLDG CODE	
QUOTE	D TO	s. 22		SPACING	SPACING		24"		РІТСН		5/12		X
REFER	ENCE	Reda	cted S. 22 ADDITION	EXT WAL	EXT WALLS		2X4 V/		T PITCH			PART4	
DATE (	ORDERED			WEBS	WEBS		2X3		CUT	P/C		FARM	
PREPARED BY		МАТ	Т	ROOFING	ROOFING DUROID		D	HEEL CUT		0-2-120/A		FLOOR	T
QTY	TYPE		DESCRIPTION		SPAN		L OVERHANG		L CANTI	LEVER R L		STUB	R2
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1	#2	OUT WA	LL GIRDER	18-0-2		NIL	. NIL	-					
1	#3	#3 OUT WALL GIRDER		19-3-0	19-3-0		NIL		-13 ₀₋₁ -13 ₀₋₁	520097-30 T 20/5	0 0 = 0000		
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SNOW LD	RAIN LD	SPACING	PITCH	WALLS	WEBS	ROOFING	END CUT	HEEL CUT	BLDCODE	CUSTOMER NAME		NOVA GROUP	WORK NO
48	4.2	24"	5/12	2X4	2X3	DUROID	P/C	0-2-12 O/A	PART 9	DELIVERY ADDRESS	140	034 MARINE DR. WHITE ROCK	2020
ANGARS SIMPS	ON	LU24L - A	LJS 26 DS	-n	HGUS 26 -	0	HGUS 28-2 - 🗇	HGUS 28-4		HGU5 48 - OO	HGUS 210- 00	SPECIAL - []	CRUSH PLATE - •







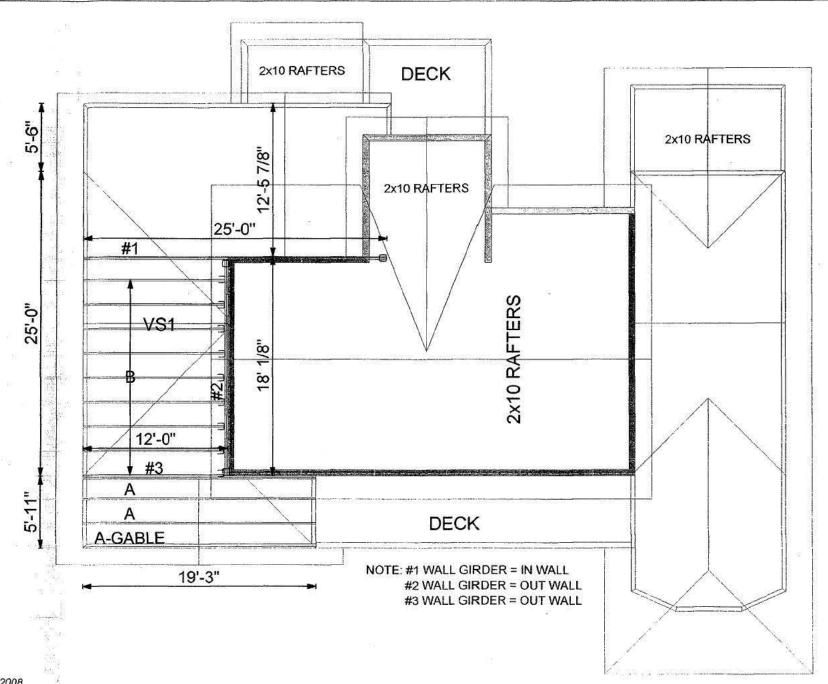

## PERMANENT BUILDING BRACING By building designer


Permanent bracing is designed and specified for the structural safety of the overall building. It is the responsibility of the building designer or authority other than the truss designer to indicate size, location and attachments for all permanent bracing. The bracing is required to maintain the proper spacing, to distribute unequal loading to adjacent trusses and to spread lateral forces to diaphragms or shear walls. Some minimum suggestions are as follows:

- On the bottom chord, lateral and diagonal braces as specified in "Temporary Bracing" can be left in place.
- 2. Lateral top chord bracing may not be required where strapping or sheathing is applied directly to the chord. If purlins are used, braces as specified for installation can be nailed to the underside of the top chord.
- Install diagonal web bracing as specified for installation and shown in Figure 4.

## PERMANENT LATERAL BRACING By truss designer

- This type of bracing is normally used on chords and/or webs to prevent buckling. If not installed, the truss will not be able to support the loads it was designed for.
- Refer to each individual truss design for the size, location and nailing of continuous lateral braces (usually 1x4 with 2 - 2½ inch nails in each member). Part 9 of The B.C. Building Code specifies that compression webs over 6 feet require braces.

- 3. If you have a single truss that requires bracing, use a T-brace, a 2x4 board nailed to the top of the web along it's full length forming a "T", as shown in Figure 10.
- 4. Permanent lateral bracing must be anchored at each end of the building. It is the responsibility of the building designer to specify a type of anchor. Figure 11 shows a possible method. Note that cross-braces to form bulkheads might serve a dual purpose if applied to the laterally braced webs.

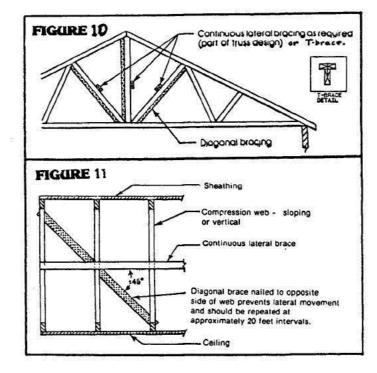



Mail: 33771 Morey Road, Abbotsford, B.C. V2S 2W5

Bus: (604) 854-6626 Fax: (604) 854-6614

**PYRAMID TRUSS** 

#### RECOMMENDED HANDLING, INSTALLING AND BRACING OF WOOD TRUSSES

#### INTRODUCTION

Individual trusses are long slender members with very little lateral strength or resistance to twisting. It is because of this that accidents involving truss collapse occur during truss installation. Most of these accidents can be prevented if correct procedures are followed for the handling, positioning and bracing of trusses at the work site.

While these recommendations for handling, installation and bracing are technically sound, it is not intended that they be considered the only method for installing and bracing a roof system. Neither should these recommendations be preferred in lieu of an architect's or engineer's design for installation and bracing a particular roof system or in lieu of W.C.B. regulations.


Due to the nature of the responsibilities involved, these recommendations must be presented only as a guide for the use of a qualified building designer, builder or contractor. Thus, the Western Wood Truss Association expressly disclaims any responsibility for damages arising from the use, application, or reliance on the recommendations and information contained herein.

## BEFORE THE TRUCK ARRIVES Preparing the site


- Provide clear, solid access for the delivery vehicle to safely reach a level unloading location. Confirm that workers will be on site to direct and assist truck driver.
- Make certain no overhead power lines will prevent safe unloading of trusses. (Consult W.C.B. regulations Section 24). If power lines are not to be de-energized, then provide alternate location where trusses can be unloaded onto the ground.
- If trusses are to be stored on site, leave trusses strapped together. Store where they will not be damaged during construction and where they are adequately supported to prevent bending or twisting.

#### HOISTING TRUSSES TO THE ROOF Safe crane procedure

- Make certain that walls or the structural building frame are properly aligned and adequately braced.
- Only workers directly involved with this work should be in the area where the trusses are being handled.
- Hoist all trusses to the roof level, taking care not to bend or twist the trusses. To prevent damage, trusses must always be handled in an upright or vertical position.
- Always attach slings at panel points, not to the middle of a truss member. For long trusses, a spreader bar or strong back may be required.

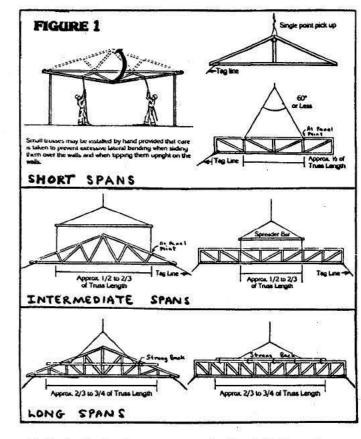


- Typical rigging arrangements for hoisting trusses are shown in Figure 1.
- If interior walls are available, trusses may be laid flat at roof level.
- If no partitions exist, trusses may be inverted and hung from the bearing plates until they can be swung into position.
- Make sure each package of trusses is stabilized before the bands are cut, to prevent damage or worker injury.

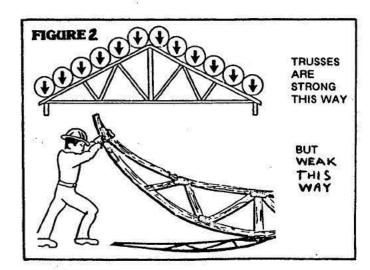


## BRACING THE FIRST TRUSS Getting a good start

 The first truss must be set at one end of the structure and fully laterally braced before erecting additional trusses. Figure 3 shows two options for bracing the first truss where the truss system itself does not provide sufficient bracing (by the jacks on a hip roof, for example). The ground brace method applies for single storey structures without the stability provided by interior walls.

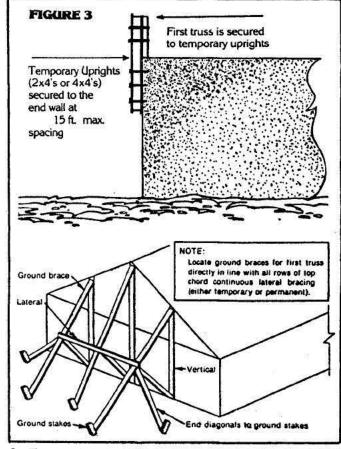

- The next two trusses must be placed, one at a time, adjacent to the first truss, plumbed, and braced to the first truss every 10 feet along the top and bottom chord.
- 3. After the first 3 trusses are positioned install cross bracing at least every 10 feet along the length the trusses. Secure bridging from the top chord of the first truss to the bottom chord of the third truss and from the bottom of the first to the top of the third. Subsequent trusses can be braced to this "bulkhead". See Figure 4.

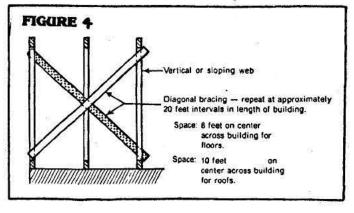

4. A clever option is to assemble the trusses on the ground in groups of 3 or 4, and brace as outlined. Using a larger crane, these groups can then be hoisted directly onto the walls, positioned and tied to the previous group.


## INSTALLATION OF TRUSSES Hints and procedures

- Have installation and bracing instructions available at the work site. Only workers instructed in the proper procedures should be in the area under the supervision of a competent person.
- Always refer to framing plans for proper location of trusses. Do not simply install them "as they come off the pile". Refer to individual truss drawings for proper location of cantilevers, interior bearings and point loads.

 Erect trusses using a string line to locate the heel. Ensure that truss is plumb and properly spaced before securing to the bearing plate using toe-nails or metal brackets.


4. A truss with broken members or damaged plates must be replaced or repaired in accordance with instructions from the truss manufacturer or a professional engineer. If possible, repair before installing truss.

 Never alter any part of any truss for any reason without professional advice. Cutting, drilling or notching any part (except the overhang) will void any expressed or implied warranty. (B.C. Code article 9.23.5.5)

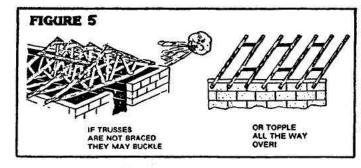

- Girders are trusses which carry other trusses, relatively large areas of framing or point loads from beams or other girders. If there is any doubt about whether a girder is needed, consult your fabricator.
- 7. Make sure multiple member girders are properly laminated (nailed and sometimes bolted) as per engineering designs before loads are applied. Also refer to designs for proper location of point loads, so truss is not installed reversed.
- 8. Ensure that the loads from girders are carried to the foundation and that the width of the bearing is adequate. Headers may need to be increased in size if supporting girders.
- Avoid placing heavy construction loads (such as stacks of plywood or roofing) on trusses, especially before they are fully braced.
- 10. Make sure that proper temporary bracing is installed as each truss is set. Never leave a job without proper bracing in place.
- 11.Trusses which do not meet interior bearing walls should be shimmed. Do not pull trusses down, they will tend to return to original camber in a few days or weeks causing drywall problems.
- 12.If trusses do not rest on outside walls properly, make sure that interior walls are not too high. (If flat trusses, make sure they are right side up). Correct with shims or by lowering high bearings.

13.Uplift is the seasonal up and down motion of the bottom chord that occurs on some installations. To avoid potential drywall problems, use floating corners at interior walls as shown in Figure 6. Reduce stress on corner joints by holding the ceiling drywall to the top plate with drywall clips, metal angles, wood blocks or wider top plates and strapping.

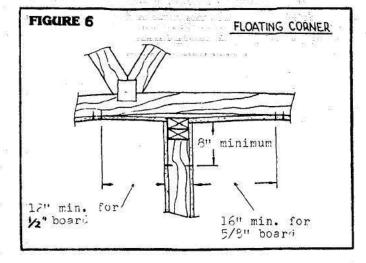



- 14.Install all necessary wind, cross-bracing and ceiling ties. Insure that all lateral bracing and T-bracing is installed as specified on each truss design drawing.
- 15.Make sure all hangers have been used in their correct location, especially where heavy hangers are supplied to carry beams or girders.
- 16.If in doubt for any reason, call your fabricator first! The effort to get to a phone will likely save time and money in the long run. Don't expect your fabricator to spend his time and money to fix what might have been corrected in minutes if you had just called first.

#### TEMPORARY BRACING Don't let them fall

 As each truss is installed it must be securely braced back to a previously braced truss (see "Bracing the First Truss"). This bracing should include continuous ties, diagonals and cross-


- bracing as described below and shown in Figures 7, 8 and 9.
- Continuous lateral ties should be at maximum 10 foot on center across top and bottom chords, placed close to a panel point. Ties should be a minimum of 8 feet long and should lap over at least 2 trusses.
- 3. Install diagonals at about a 45 degree angle between lateral ties on top and bottom chords. Diagonals should be at each end and at maximum 20 foot spacing along the building.
- 4. Approximately every 20 feet install a bulkhead like the one between the first 3 trusses (see Figure 4). These cross-braces should be as near as possible to the lines of lateral braces and may be applied to vertical or sloping webs.
- 5. For trusses up to 24 inch spacing, use 1x4 braces fastened with 2 2½ inch common nails at each member. Over 24 inches to 48 inches on center, use 2x3 or 2x4 with 2 3½ inch nails.
- The bracing shown applies to pitched or flat trusses, but refer to Figure 9 for notes on top or bottom chord bearing flat trusses.
- If it becomes necessary to correct the alignment or plumbness of a truss make sure only the minimum amount of bracing is disconnected.
- Remember that you, not the truss supplier, are responsible for all bracing, temporary or left in place.

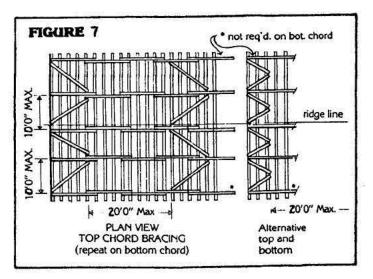

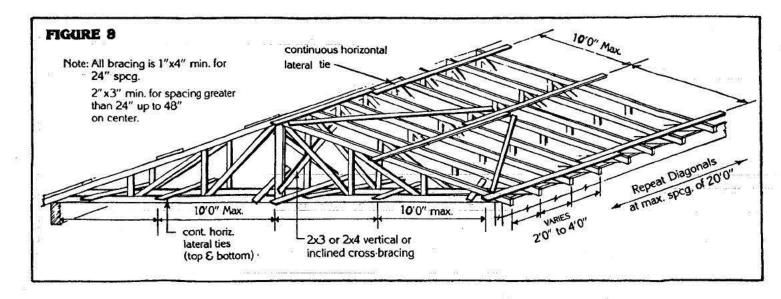

# General Plated Truss Thanger Installer's Guide

SIMPSON Strong:Tie

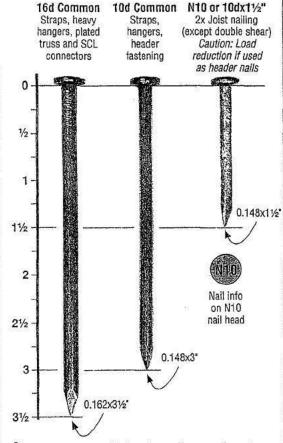

Screws may not be used to replace nails in

connectors

#### No framing nail-gun nails unless:

- 1. Correct diameter and length
- 2. Driven with a hole-locating tool (finds the hole) or by hand


DO NOT OVERDRIVE OR SHOOT THROUGH CONNECTORS







#### LU/LUL




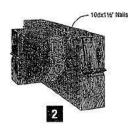

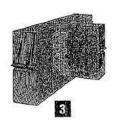

#### LUS

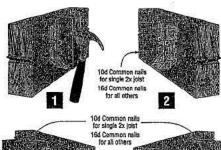

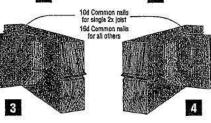

#### DOUBLE-SHEAR NAILING




Double-shear nailing shall use full length common nails



Shorter nails may not be used as double-shear nails

#### LJS26DS/HUS/HHUS/HGUS

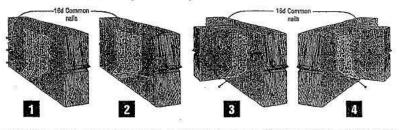

Refer to the current *Wood Construction Connectors Canadian Limit States Design* catalogue for general notes, limited warranty and additional installation information. Hangers pictured are a pictorial representation and may not reflect each individual hanger design.

This flier is effective until June 30, 2010, and reflects information available as of March 1, 2008. This information is updated periodically and should not be reflied upon after June 30, 2010; contact Simpson Strong-Tie for current information and limited warranty or see www.strongtie.com.

800-999-5099 www.strongtie.com



MiTek Canada, Inc.

100 Industrial Road Bradford, ON, Canada L3Z 3G7 Phone (905) 952-2900 Toll Free (800) 268-3434 Fax (905) 952-2901


November 20,2008

Re: 2020-NOVA

The truss drawing(s) referenced below have been prepared by or for MiTek Canada, Inc. based on the data provided by Pyramid Truss(Can-J).


Pages or sheets enclosed: J1022680 thru J1022684


The seal on these drawings indicates acceptance of professional engineering responsibility solely for the truss components shown. The suitability and use of this component for any particular building is the responsibility of the building designer. Engineering Services provided by KNH Inc

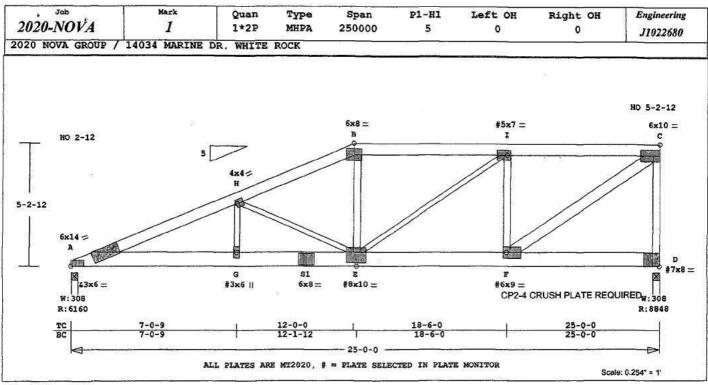

			Scale: 0.254" = 1
	Robbins Engineering,	Inc./Online Plus™ APPROX. TRUSS WEIGHT: 230.7 LB:	
Online Plus Version 23.0.017		Dist Live 80 80 16.0 25.0	#Rows Spacing (in)
RUN DATE: 19-NOV-08		Dist Dead 7 7 0.0 12.0	TC 2x 6 2 12 BC 2x 8 2 12
* 2-Ply Truss *			WB 2x 3 1 6
*********		Membr CSI P Lbs Ax1-CSI-Bnd	2x 4 1 6
2012 F2040 20020-00 W		Top Chords	2x 6 2 6
CSI -SizeLumber TC 0.94 2x 6 1650S1.5		A -H 0.70 16684 C 0.42 0.28 H -B 0.42 15032 C 0.37 0.06	"Standard Term" loading dur. fac. used in table with
BC 0.76 2x 8 195031.7		B -I 0.94 13989 C 0.36 0.57	seasoned, untreated lumber.
WB 0.95 2x 4 1650S1.5		I -C 0.83 10026 C 0.26 0.57	When 3" power driven nails
0.61 2x 3 SPF-#2B		Bottom Chords	are used, reduce nail spacing
G-H H-E E-I 0.51 2x 6 1650S1.5		A -G 0.76 15484 T 0.35 0.41 G -S1 0.40 15484 T 0.35 0.05	to 69% of original spacing. NOTE: USER MODIFIED PLATES
F -C		S1-E 0.41 15484 T 0.35 0.06	This design may have plates
ii		E -F 0.32 10026 T 0.23 0.09	selected through a plate
Importance Category : Normal		F-D 0.26 0 T 0.00 0.26	monitor.
Condition at Manufacture : Dry		G -H 0.09 699 T	Design Roof Snow Load Use:
Treatment : Untreated Service Condition : Dry		H-E 0.50 1832 C	Ground Snow Load = 48.0 psf Rain Load = 4.2 psf
SULTED CONGLETON : DIY		E-B 0.28 4388 T	Non-slippery Roof
Brace truss as follows:		E -I 0.61 4928 T	Importance Factor 1.00
O.C. From To		F -I 0.58 6635 C	Exposed to Wind Factor 1.00
TC Cont. 0- 0- 0 25- 0- 0		F -C 0.51 12469 T D -C 0.95 8624 C	Balanced Load Factor 0.55 Unbalanced Load Factor 0.00
BC 120.0" 0- 0- 0 25- 0- 0		5 -0 0,55 0024 C	FABRICATOR NOTES:
psf-Ld Dead Live Snow		TL Defl -0.39" in G -E L/746	1. MITEK CANADA INC. IS
TC 3.0 0.0 30.6		TL Panel -0.10" in B -I L/757	RESPONSIBLE ONLY FOR THE
TC+BC 10.0 0.0 30.6		(Note - TL = 1.33LL + DL) LL Defl -0.25" in G -E L/999	STRUCTURAL ADEQUACY OF THIS COMPONENT BASED ON DESIGN
TC+BC 10.0 0.0 30.6 Total 40.6 Spacing 12.0"		Shear // Grain in B -I 0.62	CRITERIA AND LOADS SHOWN.
Lumber Duration Factor 1.00		5639 32 7309 25 30 28 04	IT IS THE RESPONSIBILITY OF
Plate Duration Factor 1.00		Plates for each ply each face.	OTHERS TO VERIFY COMPONENT
TC Fb=1.00 Fc=1.00 Ft=1.00 BC Fb=1.00 Fc=1.00 Ft=1.00		PLATING CONFORMS TO TPIC AND CSA STANDARD 086.1-94, ENG.	SUITABILITY AND DIMENSIONS. 2. MITEK ENGINEERING REFERENCE
BC Fb=1.00 Fc=1.00 Ft=1.00		DESIGN IN WOOD, LATEST EDITION	SHEET, MII-7473C FORMS AN
Unfactored Reactions (Lbs)		GRIP VALUES BASED ON NET AREA	INTEGRAL PART OF THIS
Jt -DLLLSL-		PLATES MANUFACTURED BY	DESIGN.
A 1759D 843D 2360D		MITEK CANADA.	<ol> <li>DESIGN CONFORMS TO PART 9 OBC, ABC AND BCBC LATEST</li> </ol>
D 2709D 1345D 3193D		Plate - MT20 20 Ga, Net Area Plate - MT8H 20 Ga, Net Area	EDITION.
TL Factored Reactions (Lbs)		Plate - MT16 20 Ga, Net Area	EDITION.
Jt Down Uplift Horiz-		Jt Type Plt Size X Y JSI A MT20 6.0x14.0 Ctr-0.3 0.97	J. C. HUHA
A 6160		A MT20 6.0x14.0 Ctr-0.3 0.97	_ #
D 8849		H MT20 4.0x 4.0 Ctr Ctr 0.55 B MT20 6.0x 8.0 Ctr Ctr 0.75	COCCCCC
		I# MT20 5.0x 7.0 Ctr Ctr 0.87	CESSIA"
Jt Brg Size Required A 3.5" 3.3"		C MT20 6.0x10.0-1.5 Ctr 0.89	" OF THE ONE
A 3.5" 3.3" D 3.5" 1.5"		G# MT20 3.0x 6.0 Ctr Ctr 0.13	WAS OVIN
7550 (4.555.0%) 790.0%		S1 MT20 6.0x 8.0 Ctr Ctr 0.94	" A. V & C * / 1
Maximum Downward Loadcase		E# MT20 8.0x10.0-0.1-1.4 0.95 F# MT20 6.0x 9.0 1.0 Ctr 0.89	OF \
LC# 1 NonStandard Loading Dur Fetrs - Lbr 1.00 Plt 1.00		D# MT20 7.0x 8.0-0.6-0.1 0.80	5 /
Plf TC Beg End From To		\$3 DO	, <u> </u>
Dist Dead 3 3 0.0 25.0		# = Plate Monitor used	J. C. HUM
Dist Snow 31 31 0.0 25.0		Placement Tolerance Used 0.25 in.	G Z
Dist Dead 80 80 12.0 25.0 Dist Dead 55 55 12.0 25.0			PARITICAL Y
Dist Snow 168 168 12.0 25.0		NOTES:	Samelle
Dist Dead 3 3 0.0 12.0		Trusses Manufactured by:	S Soll Tarrey
Dist Snow 31 31 0.0 12.0		PYRAMID TRUSS	" X CAME
Plf BC Beg End From To Dist Dead 7 7 0.0 25.0		Analysis Conforms To: TPIC-RES , Standard Formula	- AS
Dist Dead 7 7 0.0 25.0 Dist Dead 53 53 13.0 16.0		NBCC2005	SUGINEERS
Dist Live 140 140 13.0 16.0		2 COMPLETE TRUSSES REQUIRED.	Secrete Co.
Dist Dead 30 30 16.0 25.0		Nailing (3" CW)	-23930
Robbins Engineering, Inc./Online Plus™ © 1996-2008	Version 23.0.017 Engineering - Portra	it 11/19/2008 6:43:20 PM Page 1	2011
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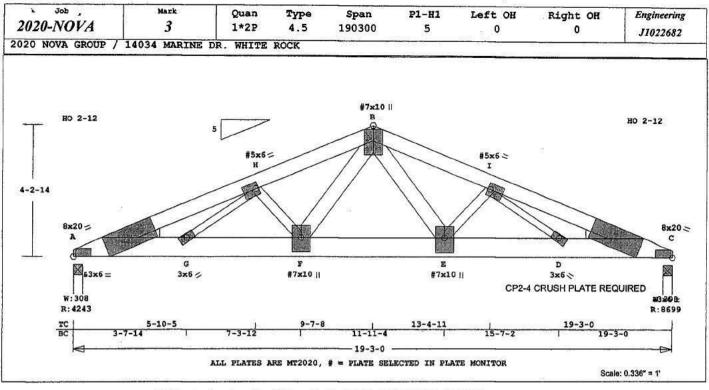


Membr A -I I -J J -K K -B	0.19	269 580	3 C	0.	14	0.1	06
J -K	0.35	EOA					
				0.		0.	
	0.39			0.	32	0.0	
K -B	0.21	290	2 C	0.	15	0.0	07
D -H	0.17	tom	O T	ras-	00	0.:	17
H -G	0.56	431		o.	24	0.3	
G-F	0.56	610	T	0	34	0.3	22
F-E	0.62	468	2 T		26		
	0.19		T	0.	00	0.1	19
		Wel					
D -A A -H	0.78	528 582	7 7				
H-I	0.81	368	2 6			33	
I -G	0.43	368: 339: 84: 79:	6 T				
G -J	0.33	84	0 0				
J -F	0.20	79	2 T				
F -K	0.48	377	5 T				
K -E	0.89	627	5 C				
E -B	0.80	568					
		1000000					
TL Def TL Pan	1 -0	.19"	in	F -	E	L/9:	99
TL Pan	el0	.01"	in	K -	В	L/9	99
(Note LL Def	- TL	- 1	331	. +	Dr)		
LL Dei Shear	1 -0	.12"	in	E -	E	L/9	
SAGAI	// GE	ain	<b>111</b>	-	G	٠.,	,,
GRIP V PLATES MITEK Plate Plate Plate Jt Typ A# MT2 I MT2 J MT2 B# MT2	CANAD - MT2 - MT8 - MT1 00 P1 20 7.	FACT 0 20 H 20 6 20 t Si 0x10 0x 8 0x 4 0x 8	Ga Ga Ga O C	Ne X	t A Y O.1 Ctr Ctr	rea rea J: 0.1	81 83 69 83
D# MTZ	0 3.	0x10	.0 (	0.1-	2.3	0.	74
H MT2	0 8.	0×12	.0	ctr	Ctr	0.1	34
G MT2 F MT2	0 5.	0×10 0×10					
E MT2		0×12					
C# MT2		0×10	.0	tr-	2.2	o.	74
# = Pl Placem	ate Ment T	onit	ance	naec	i ed	0.2	5 i:
NOTES:		ufac					

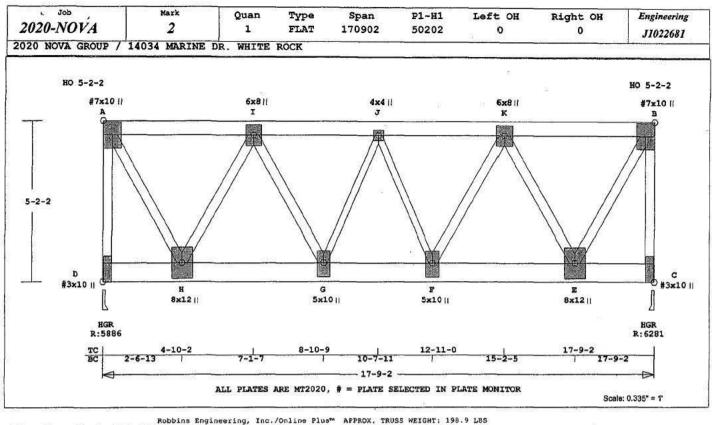
TPIC-RES , Standard Formula NECC2005

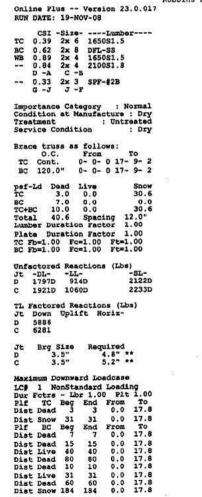Provide drainage to prevent water ponding. This truss must be installed as shown. It cannot be installed as shown. It cannot be installed used to the season of the season of





The state of the s	THE CONTRACTOR OF THE CONTRACT	
	Robbins Engineering, Inc./Online Plus™ APPROX. TRU	USS WEIGHT: 167.1 LBS
Online Plus Version 23.0.017	Dist Dead 75 75 12.0 19.	
RUN DATE: 19-NOV-08	Dist Snow 230 230 12.0 19.	
***********	Dist Dead 7 7 0.0 12.	
* 2-Ply Truss *		2× 4 1 6
***************************************	Membr CSI P Lbs Ax1-CSI-Bn	d 2x 6 2 6 6 7 Standard Term" loading
CSI -SizeLumber	Top Chords	
C 0.98 2x 6 1650S1.5	A -H 0.47 11415 C 0.27 0.2	
C 0.97 2x 8 1950S1.7	H -B 0.29 11021 C 0.25 0.0	
B 0.72 2x 6 SPF-#2B	B -I 0.43 16743 C 0.38 0.0	5 are used, reduce nail spacing
- 0.49 2x 3 SPF-#2B	I -C 0.98 21051 C 0.49 0.4	9 to 69% of original spacing.
G-H I-D	Bottom Chords	
- 0.11 2x 4 SPF-#2B	A -G 0.51 10608 T 0.24 0.2	
R-F E-I	G -F 0.43 10522 T 0.24 0.1	
B 2x 4 SPF-#2B	F-E 0.27 9639 T 0.22 0.0	
15 71 3000 92555500	E -D 0.75 16475 T 0.38 0.3	
mportance Category : Normal	D -C 0.97 19585 T 0.45 0.5	
condition at Manufacture : Dry	G -H 0.02 132 T	THE POST
Freatment : Untreated Service Condition : Dry	H -F 0.04 616 C	Non-slippery Roof Importance Factor 1.00
METATOM CONDITION : Dry	F-B 0.07 1007 T	Exposed to Wind Factor 1.00
race truss as follows:	B -E 0.72 11116 T	Balanced Load Factor 0.55
O.C. From To	E -I 0.11 1747 C	Unbalanced Load Factor 0.00
TC Cont. 0- 0- 0 19- 3- 0	I -D 0.49 3981 T	FABRICATOR NOTES:
BC 120.0" 0- 0- 0 19- 3- 0	AND R MARKET TO SAME	1. MITEK CANADA INC. IS
	TL Defl -0.42" in E -D L/53	
sf-Ld Dead Live Snow	TL Panel -0.07" in I -D L/80	
C 3.0 0.0 30.6 C 7.0 0.0 0.0	(Note - TL = 1.33LL + DL) LL Defl -0.27" in E -D L/83	COMPONENT BASED ON DESIGN CRITERIA AND LOADS SHOWN.
C+BC 10.0 0.0 30.6	Shear // Grain in E -D 0.5	
otal 40.6 Spacing 12.0"	Person of any and a residue	OTHERS TO VERIFY COMPONENT
umber Duration Factor 1.00	Plates for each ply each face	
late Duration Factor 1.00	PLATING CONFORMS TO TPIC AND	2. MITEK ENGINEERING REFERENCE
C Fb=1.00 Fc=1.00 Ft=1.00	CSA STANDARD 086.1-94, ENG.	SHEET, MII-7473C FORMS AN
C Fb=1.00 Fc=1.00 Ft=1.00	DESIGN IN WOOD, LATEST EDITIO	
	GRIP VALUES BASED ON NET AREA	
nfactored Reactions (Lbs)	PLATES MANUFACTURED BY	3. DESIGN CONFORMS TO PART 9 OBC, ABC AND BCBC LATEST
t -DLLLSL-	MITEK CANADA. Plate - MT20 20 Ga, Net Area	EDITION.
1161D 572D 1671D 2588D 1717D 3071D	Plate - MT8H 20 Ga, Net Area	EDITION.
2588D 1717D 3071D	Plate - MT16 20 Ga, Net Area	
L Factored Reactions (Lbs)	Jt Type Plt Size X Y JS	I
t Down Uplift Horiz-	A MT20 8.0x20.0 3.9 0.3 0.8	8 Last Surveyorin
4244	H# MT20 5.0x 6.0-1.8-0.8 0.1	2 CCCCCC-
8700	B# MT20 7.0x10.0 Ctr-0.5 0.8	100,500,500
	I# MT20 5.0x 6.0 1.8-0.8 0.6	3 100 6 20 010 10
t Brg Size Required	C MT20 8.0x20.0-3.9 0.3 0.8	
3.5" 2.3"	G MT20 3.0x 6.0 Ctr Ctr 0.8 F# MT20 7.0x10.0 Ctr-0.4 0.0	NOVINO V.
3.5" 4.7" **		6 4 / 8 K
	E# MT20 7.0x10.0 Ctr-0.6 0.8 D MT20 3.0x 6.0 Ctr Ctr 0.8	" / ' OF '\'
aximum Downward Loadcase	D M120 3.0x 0.0 CC1 CC1 V.0	
C# 1 NonStandard Loading	# = Plate Monitor used	, ————————————————————————————————————
our Fetrs - Lbr 1.00 Plt 1.00 Plf TC Beg End From To	Placement Tolerance Used 0.25	in. I C HILLAN
dist Dead 3 3 0.0 19.2		
ist Snow 31 31 0.0 19.2		
Dist Dead 3 3 0.0 9.6	NOTES:	6 // Legitishir L
ist Snow 31 31 0.0 9.6	Trusses Manufactured by:	Same
Dist Dead 3 3 9.6 12.0	PYRAMID TRUSS	" \\ \\ \\ \\ \\ \\ \\ \\ \\ \\ \\ \\ \\
ist Snow 31 31 9.6 12.0	Analysis Conforms To:	2 Wrome
1f BC Beg End From To	TPIC-RES , Standard Formul	· 45=== 1/2 %
ist Dead 7 7 0.0 19.2	NBCC2005 2 COMPLETE TRUSSES REQUIRED.	VGINEDAD
ist Dead 83 83 13.0 19.2	Nailing (3" CW)	In. J. C. HUM  OF  J.
ist Live 220 220 13.0 19.2 ist Dead 80 80 12.0 19.2	#Rows Spacing (in)	-3337-
	는 그림을 가장하다 되었습니다. 그림을 보는 그림을 보는 것이 되었습니다. 그림을 보고 있는 그림을 보고 있었습니다. 그림을 보는 사람들이 모르는 것이 되었습니다.	
bbins Engineering, Inc./Online Plus™ © 1996-2008 \	ersion 23.0.017 Engineering - Portrait 11/19/2008 6:43:21 PM Page 1	20 November 200

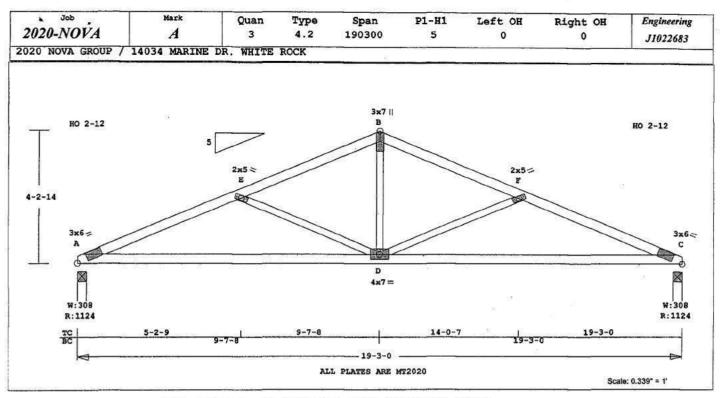

Online Plus -- Version 23.0.017 RUN DATE: 19-NOV-08

CSI -Size- ----Lumber---TC 0.38 2x 4 SPF-#2B
BC 0.63 2x 4 SPF-#2B
WB 0.33 2x 3 SPF-#2B

Importance Category : Normal Condition at Manufacture : Dry Treatment : Untreated Service Condition : Dry

Brace truss as follows:

O.C. From To TC Cont. 0-0-019-3-0 BC 120.0" 0-0-019-3-0

psf-Ld Dead Live Snow 3.0 0.0 30.6 TC 0.0 BC TC+BC 10.0 0.0 30.6 40.6 Spacing 24.0" Total Lumber Duration Factor 1.00 Plate Duration Factor 1.00 TC Fb=1.10 Fc=1.10 Ft=1.10 BC Fb=1.10 Fc=1.10 Ft=1.10

Unfactored Reactions (Lbs)
Jt -DL- -LL- -SLA 193D 0U 589D
C 192D 0U 589D

TL Factored Reactions (Lbs) Jt Down Uplift Horiz-

A 1124 C 1124

Jt Brg Size Required A 3.5" 1.5" C 3.5" 1.5"

Maximum Downward Loadcase
LC# 1 Snow Loading
Dur Fctrs - Lbr 1.00 Plt 1.00
Plf TC Beg End From To
Dist Dead 6 6 0.0 19.2

Robbins Engineering, Inc./Online Plus APPROX. TRUSS WEIGHT: 93.8 LBS
0.017 Dist Snow 61 61 0.0 19.2
Plf BC Bag End From To
Dist Dead 14 14 0.0 19.2

Membr CSI P Lbs Ax1-CSI-Bnd ----Top Chords----A -E 0.38 2272 C 0.07 0.32 E-B 0.31 1569 C 0.03 0.27 0.31 1569 C 0.03 0.27 -F 2272 C 0.07 F -C 0.38 0.32 ---Bottom Chords-----A -D 0.63 2133 T 0.34 0 29 D -C 0.63 2133 T 0.34 0.29 --Webs-----E -D 0.33 769 C D -B 0.19 847 T D -F 0.33 769 C

TL Defl -0.32" in A -D L/695
TL Panel -0.09" in F -C L/625
(Note - TL = 1.33LL + DL)
LL Defl -0.19" in A -D L/999
Shear // Grain in A -E 0.22

Plates for each ply each face. PLATING CONFORMS TO TPIC AND CSA STANDARD 086.1-94, ENG. DESIGN IN WOOD, LATEST EDITION GRIP VALUES BASED ON NET AREA PLATES MANUFACTURED BY MITEK CANADA.

Plate - MT20 20 Ga, Net Area Plate - MT8H 18 Ga, Net Area Plate - MT16 16 Ga, Net Area Jt Type Plt Size X Y JSI A MT20 3.0x 6.0 Ctr Ctr 0.89 E MT20 2.0x 5.0 Ctr Ctr 0.37 B MT20 3.0x 7.0 Ctr-0.3 0.68 F MT20 2.0x 5.0 Ctr Ctr 0.37 C MT20 3.0x 6.0 Ctr Ctr 0.89 D MT20 4.0x 7.0 Ctr Ctr 0.89

Placement Tolerance Used 0.25 in.

NOTES:

Dist Dead 6 6 0.0 19.2 Trusses Manufactured by:
Robbins Engineering, Inc./Online Plus® © 1996-2008 Version 23.0.017 Engineering - Portrait 11/19/2008 6:43:22 PM Page 1

PYRAMID TRUSS
Analysis Conforms To:
TPIC-RES , Modified Formula
NBCC2005

Design Roof Snow Load Use:
Ground Snow Load = 48.0 psf
Rain Load = 4.2 psf


Non-slippery Roof
Importance Factor 1.00
Exposed to Wind Factor 1.00
Balanced Load Factor 0.55


Unbalanced Load Factor

0.00

FABRICATOR NOTES:

- 1. MITEK CANADA INC. IS
  RESPONSIBLE ONLY FOR THE
  STRUCTURAL ADEQUACY OF THIS
  COMPONENT BASED ON DESIGN
  CRITERIA AND LOADS SHOWN.
  IT IS THE RESPONSIBILITY OF
  OTHERS TO VERIFY COMPONENT
  SUITABILITY AND DIMENSIONS.
- 2. MITEK ENGINEERING REFERENCE SHEET, MII-7473C FORMS AN INTEGRAL PART OF THIS DESIGN.
- DESIGN CONFORMS TO PART 9 OBC, ABC AND BCBC LATEST EDITION.

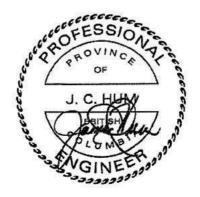

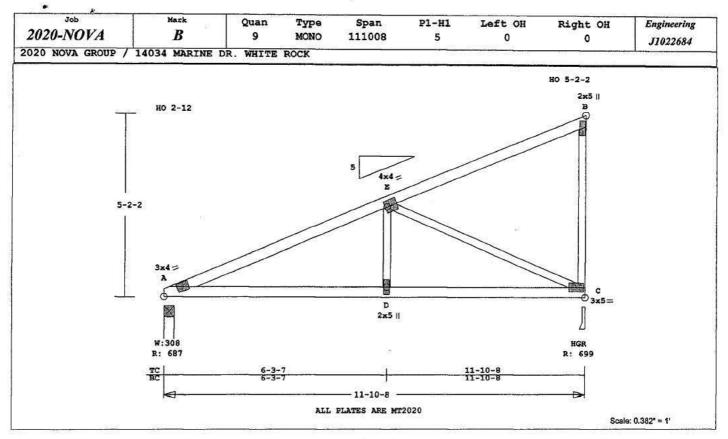

Online Plus -- Version 23.0.017 RUN DATE: 19-NOV-08

CSI -Size- --- Lumber---TC 0.41 2x 4 SPF-#2B
BC 0.43 2x 4 SPF-#2B
WB 0.70 2x 3 SPF-#2B

Importance Category : Normal Condition at Manufacture : Dry Treatment : Untreated Service Condition : Dry

Brace truss as follows:

O.C. From To TC Cont. 0-0-011-10-8 BC 120.0" 0-0-011-10-8

psf-Ld Dead 3.0 TC 0.0 30.6 0.0 0.0 BC 0.0 30.6 10.0 TC+BC Spacing 24.0" Lumber Duration Factor 1.00 Plate Duration Factor 1.00 TC Fb=1.10 Fc=1.10 Ft=1.10 BC Fb=1.10 Fc=1.10 Ft=1.10

Unfactored Reactions (Lbs)
Jt -DL - LL- -SLA 118D 0U 360D
C 120D 0U 367D

TL Factored Reactions (Lbs)
Jt Down Uplift HorizA 687
C 700

Jt Brg Size Required A 3.5" 1.5" C 3.5" 1.5"

Maximum Downward Loadcase
LC# 1 Snow Loading
Dur Fotrs - Lbr 1.00 Plt 1.00
Plf TC Beg End From To
Dist Dead 6 6 0.0 11.9
Dist Snow 61 61 0.0 11.9

Robbins Engineering, Inc./Online Plus[®] APPROX. TRUSS WEIGHT: 64.3 LBS 0.017 Plf BC Beg End From To Dist Dead 14 14 0.0 11.9

TL Def1 -0.15" in A -D L/892
TL Panel -0.15" in A -E L/488
(Note - TL = 1.33LL + DL)
LL Def1 -0.11" in A -D L/999
Shear // Grain in A -E 0.25

Plates for each ply each face. PLATING CONFORMS TO TPIC AND CSA STANDARD 086.1-94, ENG. DESIGN IN WOOD, LATEST EDITION GRIP VALUES BASED ON NET AREA PLATES MANUFACTURED BY MITEK CANADA.

MITER CANADA.
Plate - MT20 20 Ga, Net Area
Plate - MT8H 18 Ga, Net Area
Plate - MT16 16 Ga, Net Area
Jt Type Plt Size X Y JSI
A MT20 3.0x 4.0 Ctr Ctr 0.61
E MT20 4.0x 4.0 Ctr Ctr 0.65
B MT20 2.0x 5.0 Ctr Ctr 0.12
C MT20 3.0x 5.0 -0.5 Ctr 0.12
C MT20 3.0x 5.0 -0.5 Ctr 0.67

Placement Tolerance Used 0.25 in.

NOTES: Trusses Manufactured by: PYRAMID TRUSS Analysis Conforms To: TPIC-RES , Modified Formula NBCC2005 Design Roof Snow Load Use: Ground Snow Load = 48.0 psf Rain Load = 4.2 psf Non-slippery Roof

Importance Factor 1.00
Exposed to Wind Factor 1.00
Balanced Load Factor 0.55
Unbalanced Load Factor 0.00
FABRICATOR NOTES:

- 1. MITEK CANADA INC. IS
  RESPONSIBLE ONLY FOR THE
  STRUCTURAL ADEQUACY OF THIS
  COMPONENT BASED ON DESIGN
  CRITERIA AND LOADS SHOWN.
  IT IS THE RESPONSIBILITY OF
  OTHERS TO VERIFY COMPONENT
  SUITABILITY AND DIMENSIONS.
- MITEK ENGINEERING REFERENCE SHEET, MII-7473C FORMS AN INTEGRAL PART OF THIS DESIGN.
   DESIGN CONFORMS TO PART 9
- DESIGN CONFORMS TO PART 9 OBC, ABC AND BCBC LATEST EDITION.




## **Symbols**

#### PLATE LOCATION AND ORIENTATION



Center plate on joint unless x, v offsets are indicated Dimensions are in ft-in-sixteenths or mm. Apply plates to both sides of truss and fully embed teeth.

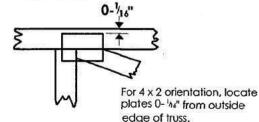

This symbol indicates the required direction of slots in connector plates.

*Plate location details available in MITek software or upon request.

#### PLATE SIZE

4 x 4

The first dimension is the plate width measured perpendicular to slots. Second dimension is the length parallel to stots.

#### LATERAL BRACING LOCATION



Indicated by symbol shown and/or by text in the bracing section of the output. Use T, I or Eliminator bracina if indicated.

#### BEARING



Indicates location where bearings (supports) occur. Icons vary but reaction section indicates joint number where bearings occur.

#### Industry Standards:

Truss Design Procedures and Specifications for Light Metal Plate Connected Wood Trusses


DSB-89: Design Standard for Bracing.

BCSI1:

Building Component Safety Information, Guide to Good Practice for Handling. Installing & Bracing of Metal Plate Connected Wood Trusses.

## **Numbering System**

dimensions shown in ft-in-sixteenths or mm (Drawings not to scale)

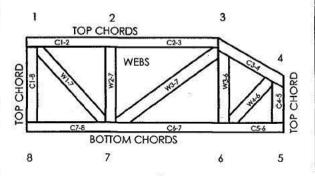

JOINTS ARE GENERALLY NUMBERED/LETTERED CLOCKWISE AROUND THE TRUSS STARTING AT THE JOINT FARTHEST TO THE LEFT.

CHORDS AND WEBS ARE IDENTIFIED BY END JOINT NUMBERS/LETTERS.

#### PRODUCT CODE APPROVALS

**CCMC** Reports:

11996-L, 10319-L, 13270-L, 12691-R

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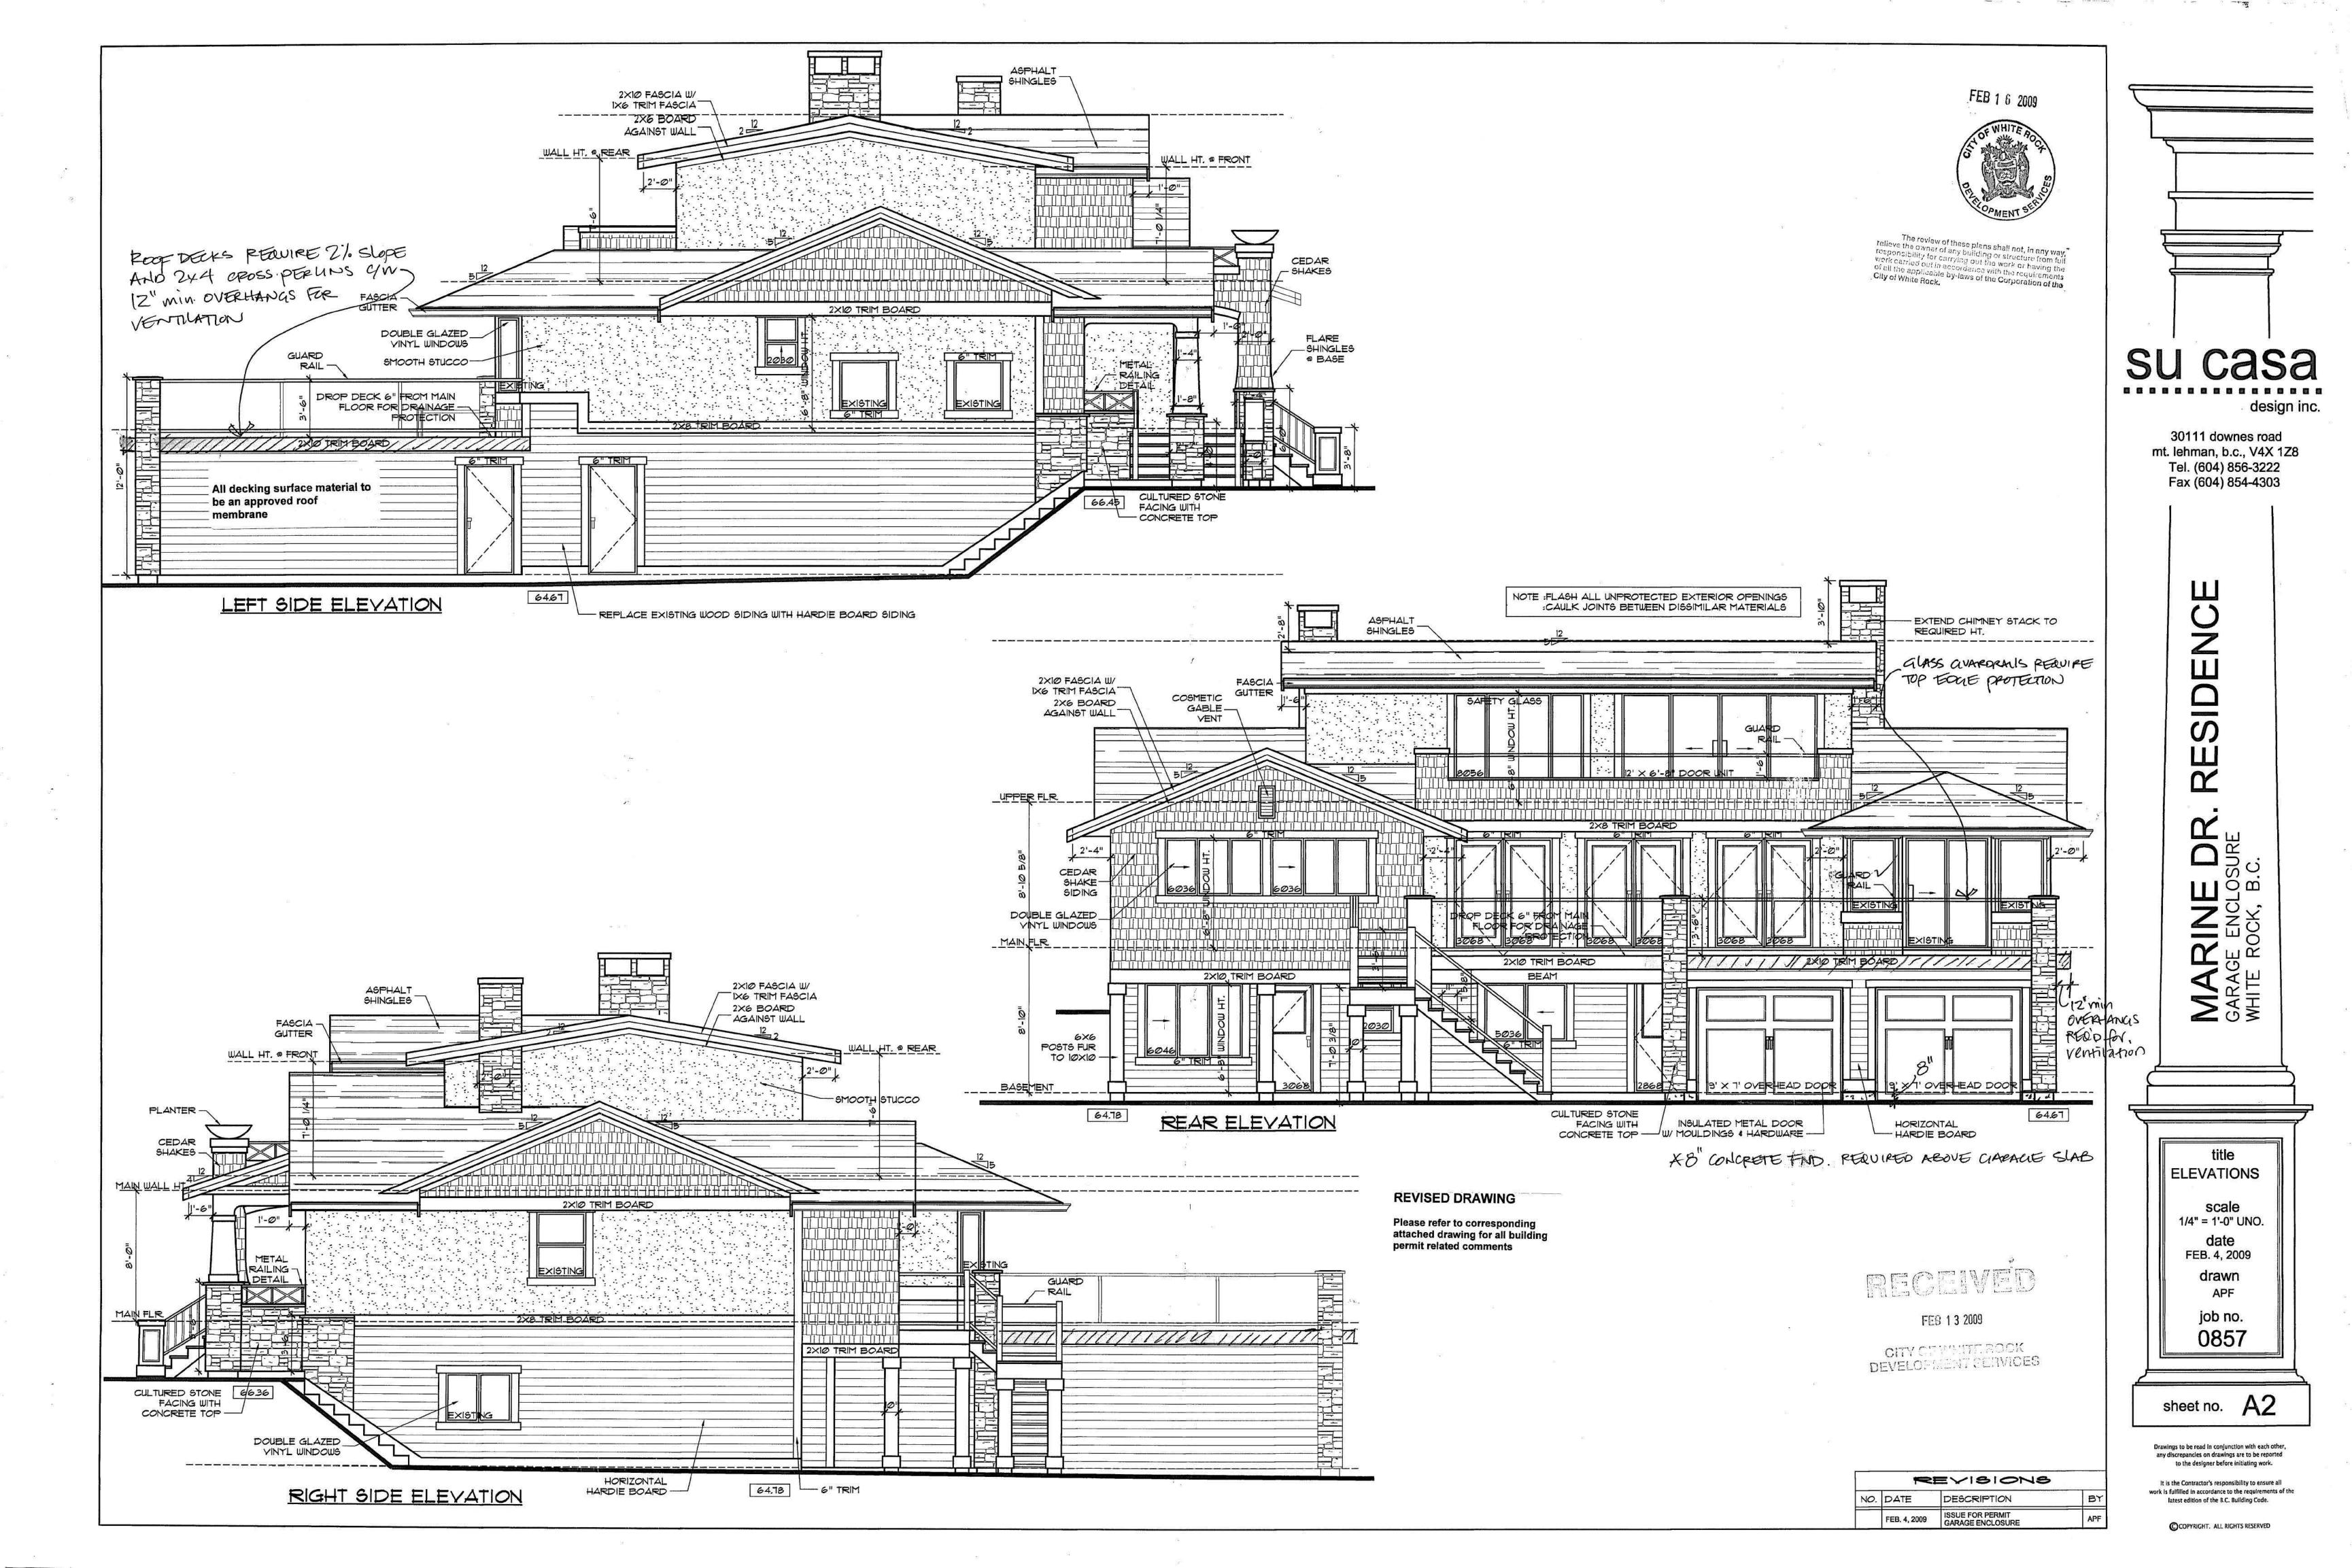
MiTek Engineering Reference Sheet: MII-7473C





## General Safety Notes

Failure to Follow Could Cause Property Damage or Personal Injury


- 1. Additional stability bracing for truss system, e.g. diagonal or X-bracina, is always required. See BCSI1.
- 2. Truss bracing must be designed by an engineer. For wide truss spacing, individual lateral braces themselves may require bracing, or alternative T. I. or Eliminator bracing should be considered.
- 3. Never exceed the design loading shown and never stack materials on inadequately braced trusses.
- 4. Provide copies of this truss design to the building designer, erection supervisor, property owner and all other interested parties.
- 5. Cut members to bear tightly against each other.
- 6. Place plates on each face of truss at each joint and embed fully. Knots and wane at joint locations are regulated by TPIC.
- 7. Design assumes trusses will be suitably protected from the environment in accord with TPIC.
- 8. Unless otherwise noted, moisture content of lumber shall not exceed 19% at time of fabrication.
- 9. Unless expressly noted, this design is not applicable for use with fire retordant, preservative treated, or green lumber.
- 10. Camber is a non-structural consideration and is the responsibility of truss fabricator. General practice is to camber for dead load deflection.
- 11. Plate type, size, orientation and location dimensions indicated are minimum plating requirements.
- 12. Lumber used shall be of the species and size, and in all respects, equal to or better than that specified.
- 13. Top chards must be sheathed or purlins provided at spacing indicated on design.
- 14. Bottom chords require lateral bracing at 10 ft. spacing, or less, if no ceiling is installed, unless otherwise noted.
- 15. Connections not shown are the responsibility of others.
- 16. Do not cut or after truss member or plate without prior approval of an engineer.
- 17. Install and load vertically unless indicated otherwise.
- 18. Use of green or treated lumber may pose unacceptable environmental, health or performance risks. Consult with project engineer before use.
- 19. Review all portions of this design (front, back, words and pictures) before use. Reviewing pictures alone is not sufficient.
- 20. Design assumes manufacture in accordance with TPIC Quality Criteria.



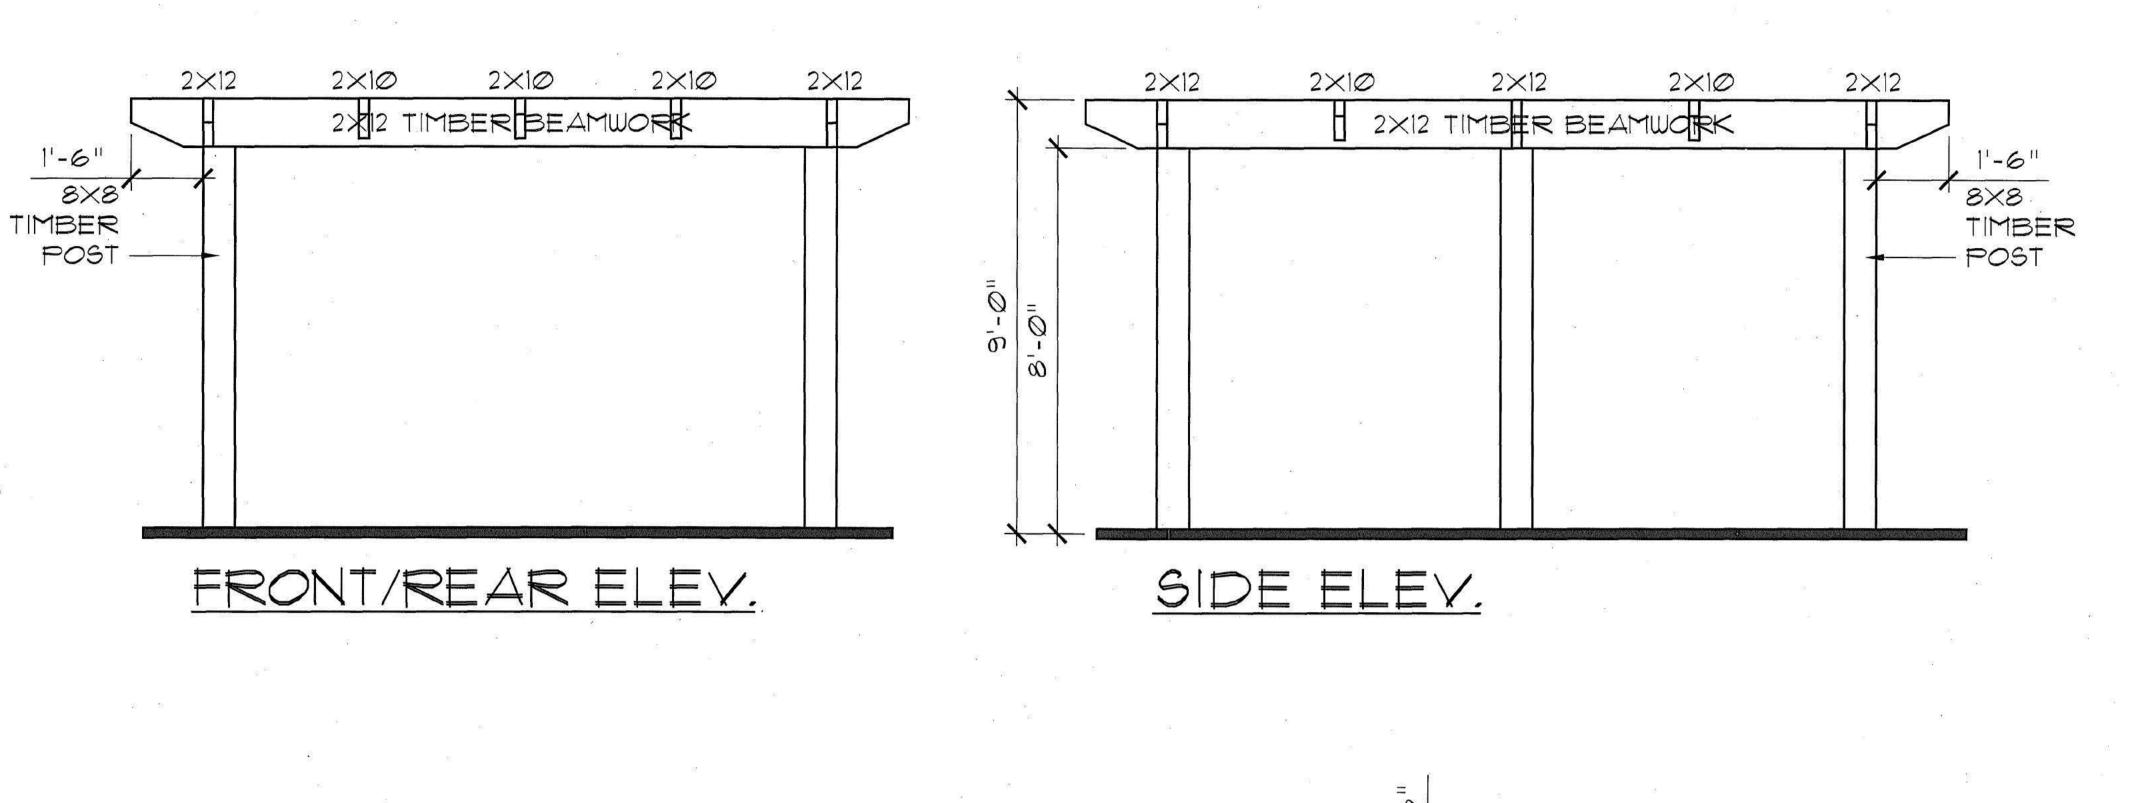

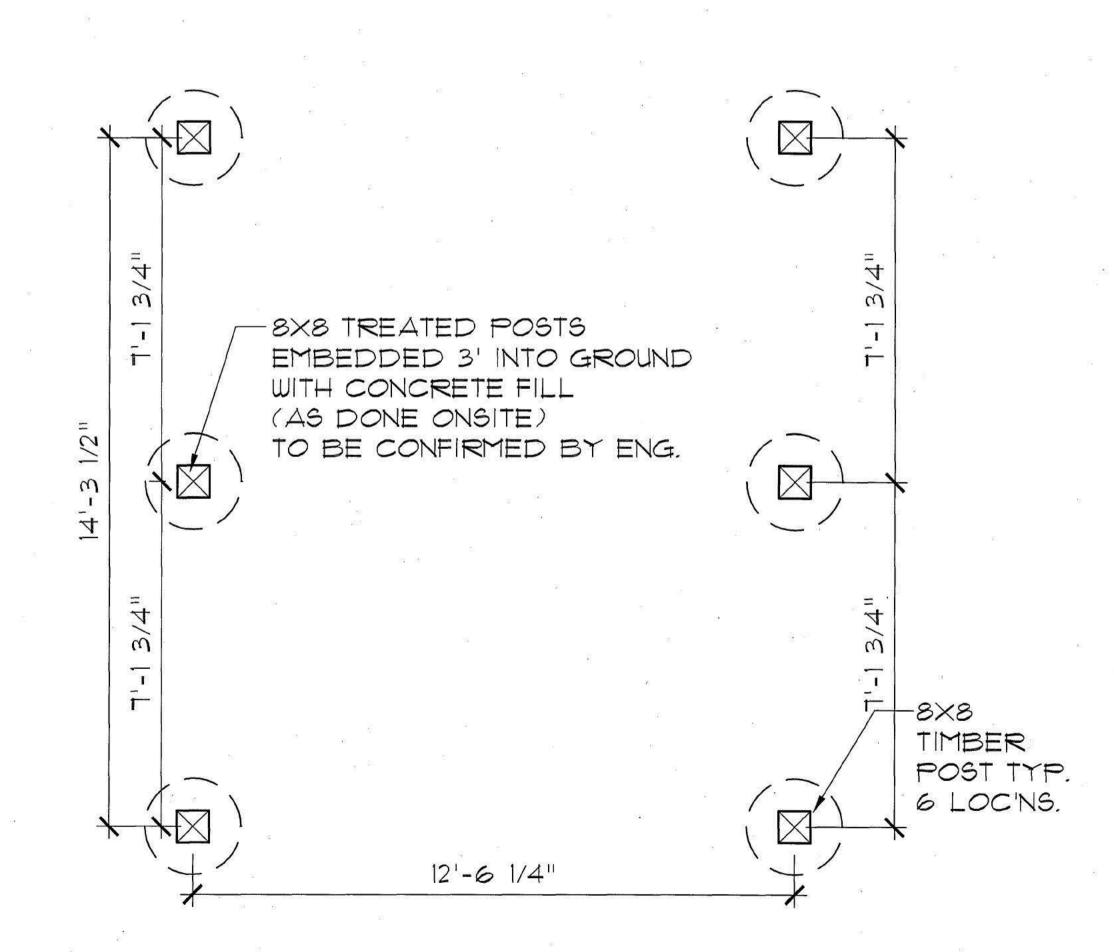



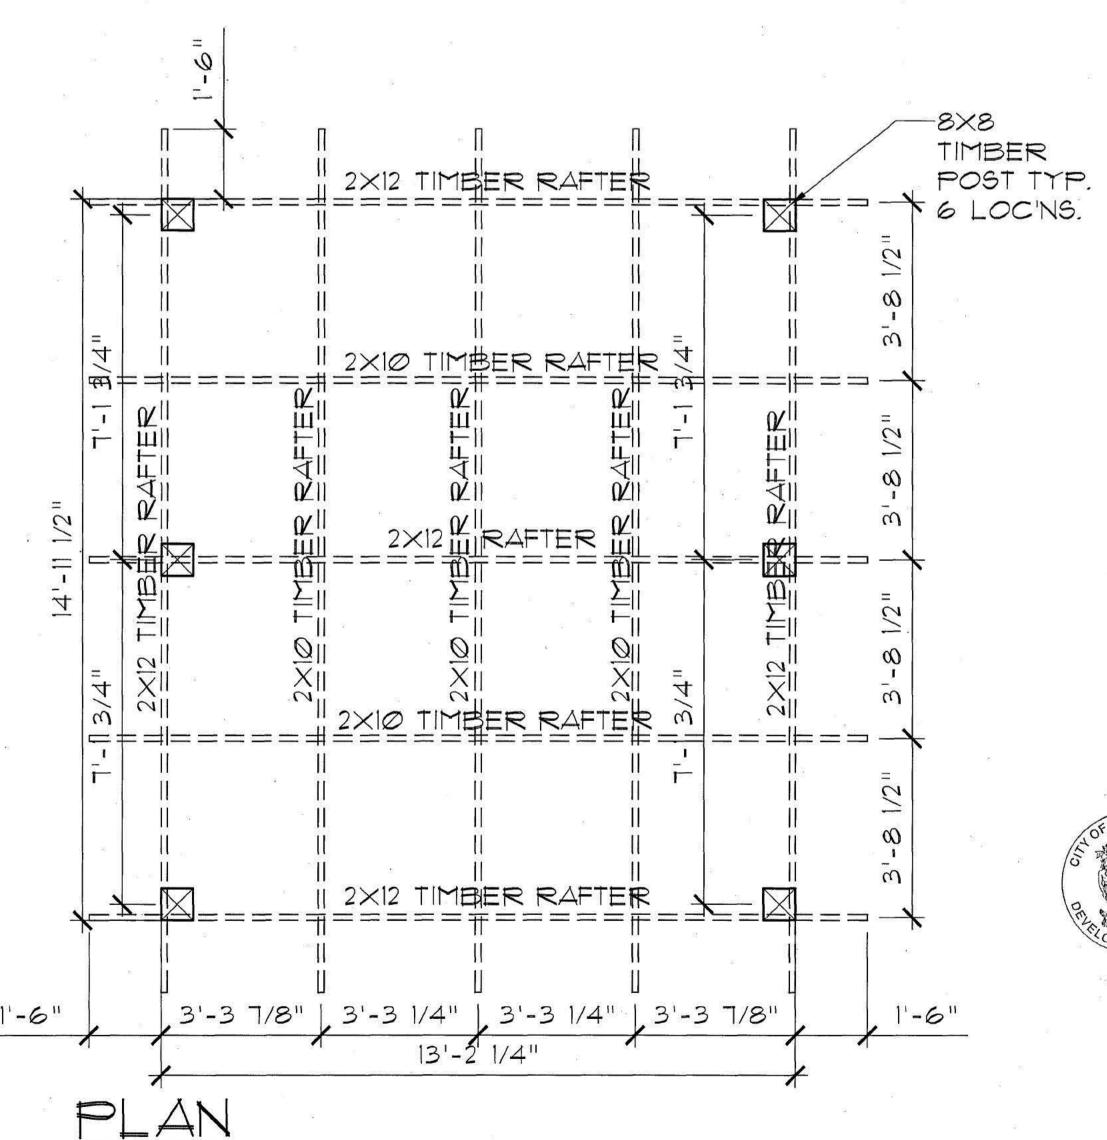





FRE	evisions	
DATE	DESCRIPTION	BY
OCT. 20, 2008	ISSUE FOR PERMIT	APF
	DATE	

Drawings to be read in conjunction with each other, any discrepancies on drawings are to be reported to the designer before initiating work, 1 APR. 21, 2009 PERGOLA ADDITION


su casa 30111 downes road mt. lehman, b.c., V4X 1Z8 Tel. (604) 856-3222 Fax (604) 854-4303


**PERGOLA** 1/2" = 1'-0" UNO. OCT. 20, 2008

drawn

A7a sheet no.

It is the Contractor's responsibility to ensure all work is fulfilled in accordance to the requirements of the latest edition of the B.C. Building Code.

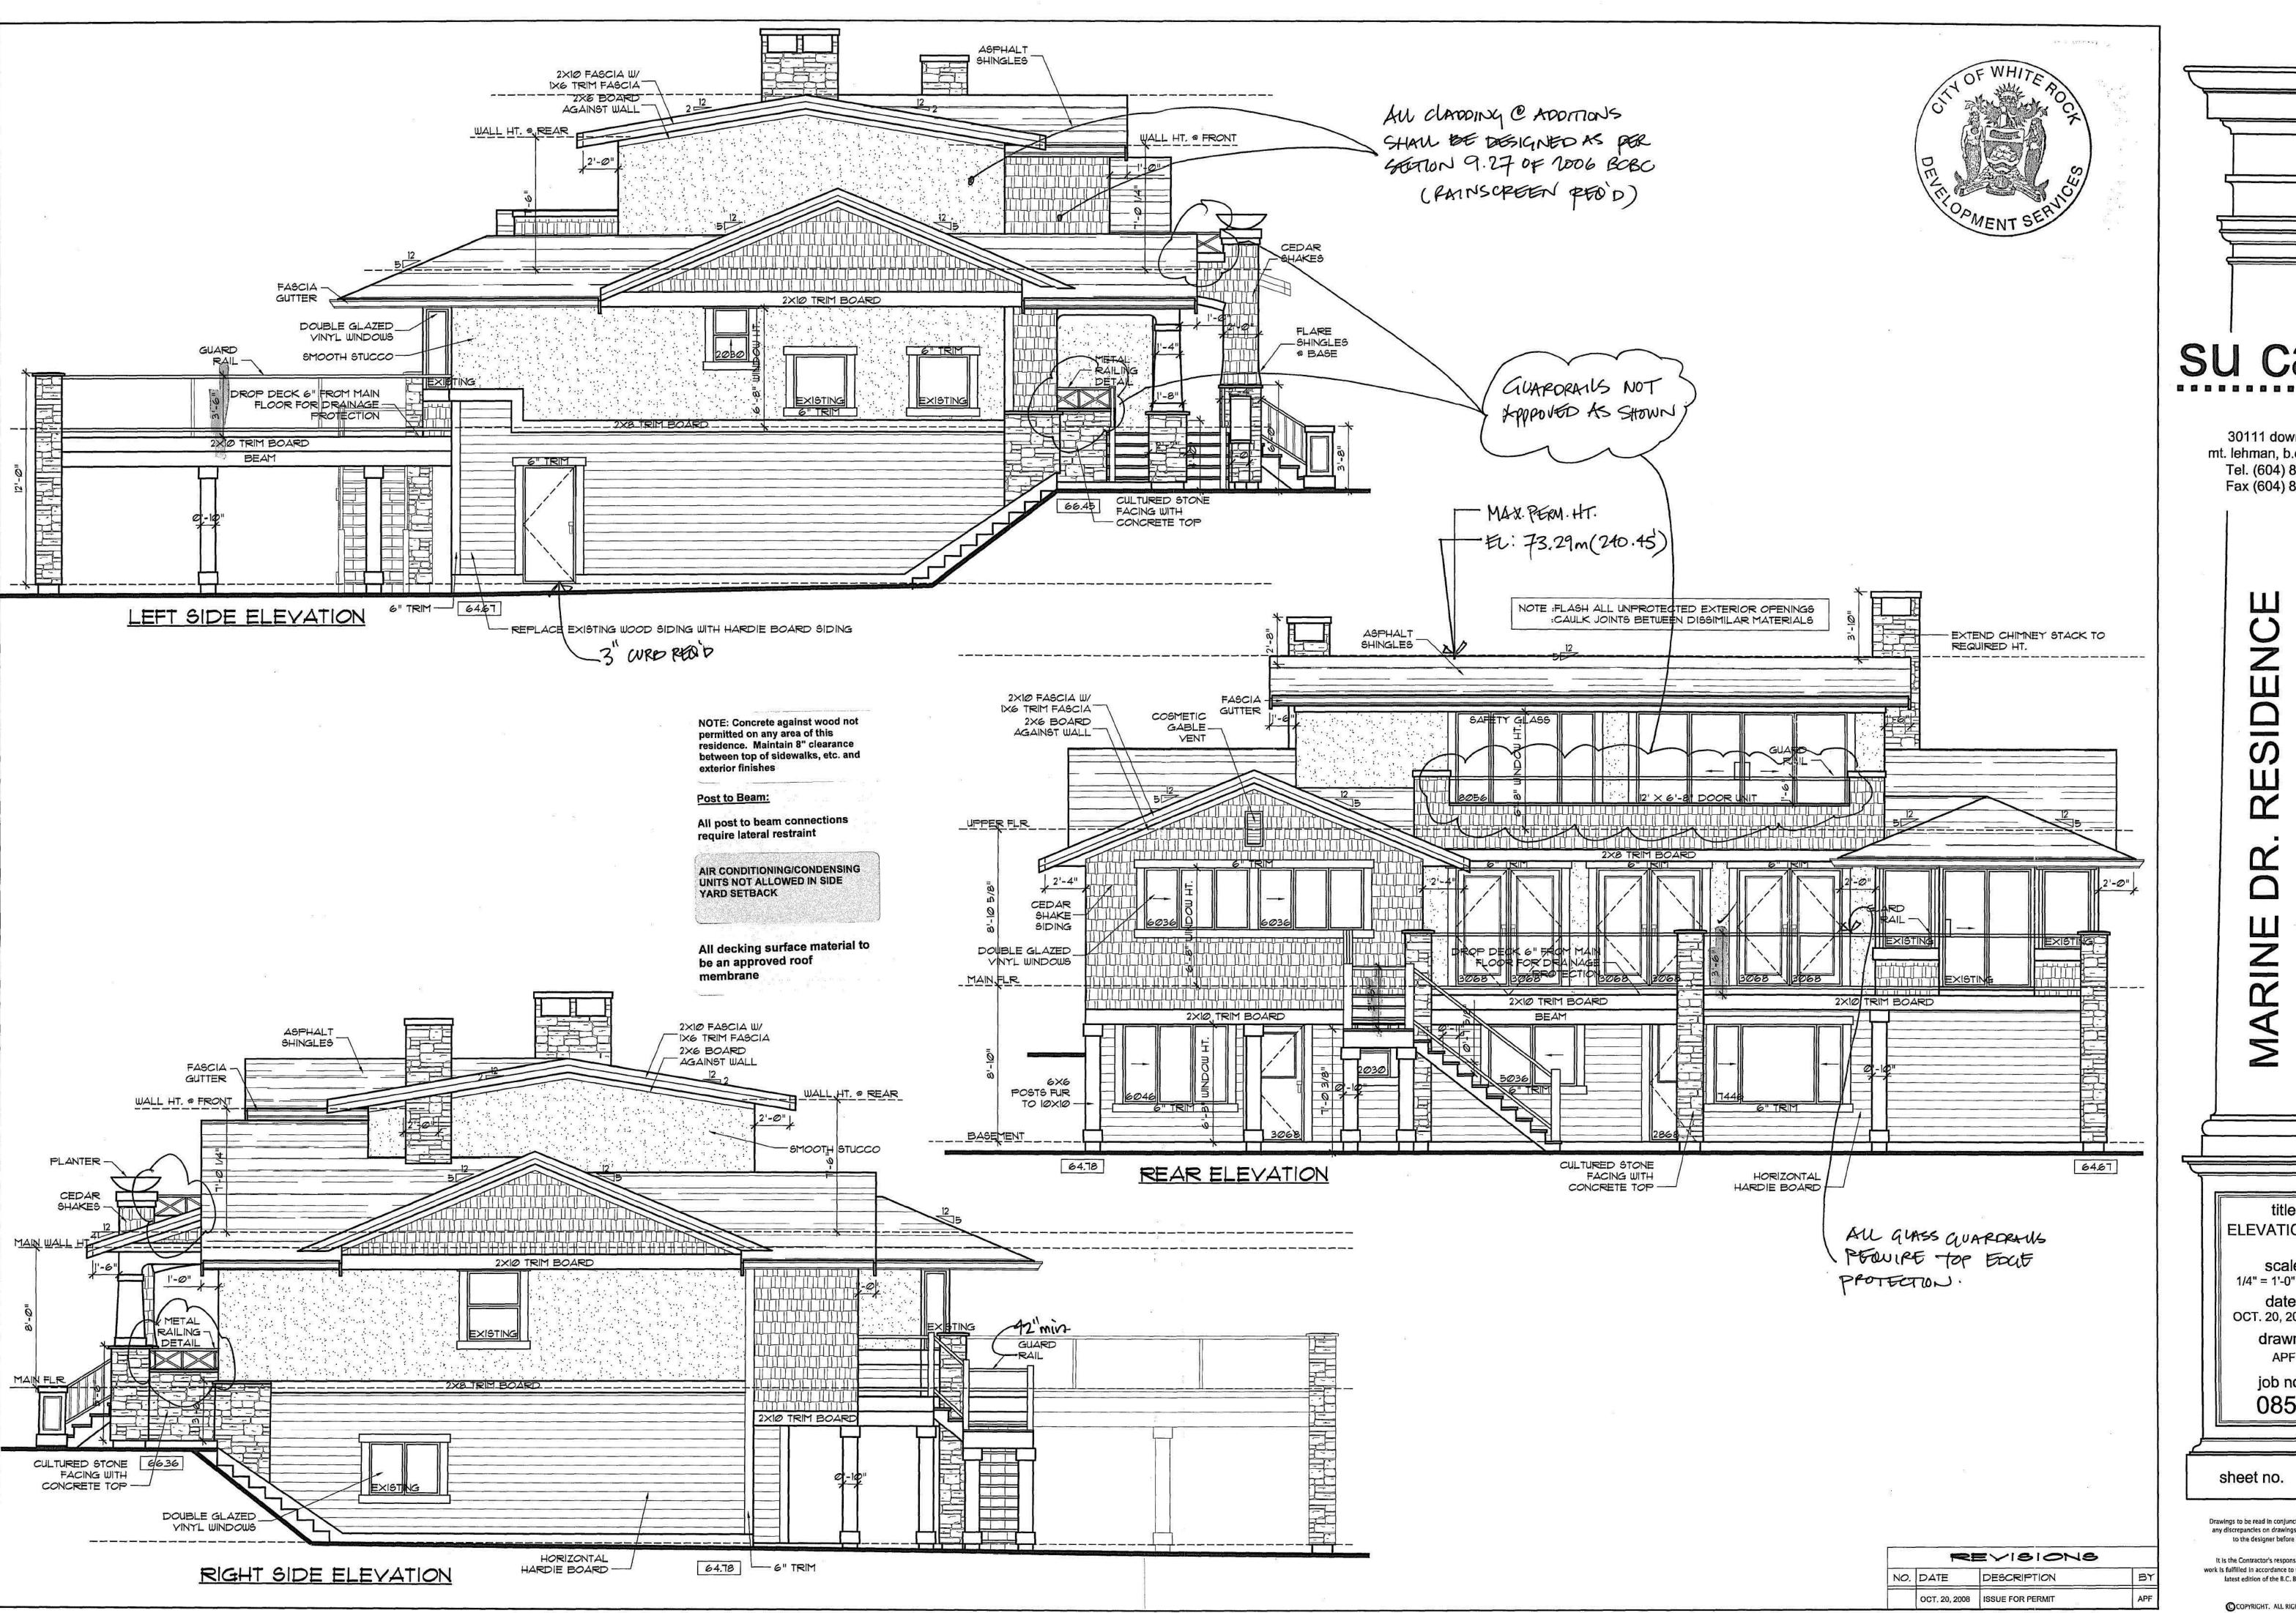

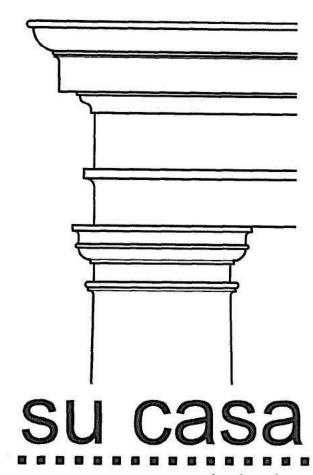


30111 downes road mt. lehman, b.c., V4X 1Z8 Tel. (604) 856-3222 Fax (604) 854-4303


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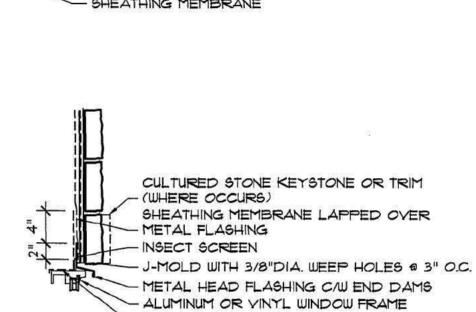
title ELEVATIONS scale 1/4" = 1'-0" UNO. OCT. 20, 2008 drawn job no. 0857

Drawings to be read in conjunction with each other, any discrepancies on drawings are to be reported to the designer before initiating work.

It is the Contractor's responsibility to ensure all work is fulfilled in accordance to the requirements of the latest edition of the B.C. Building Code.



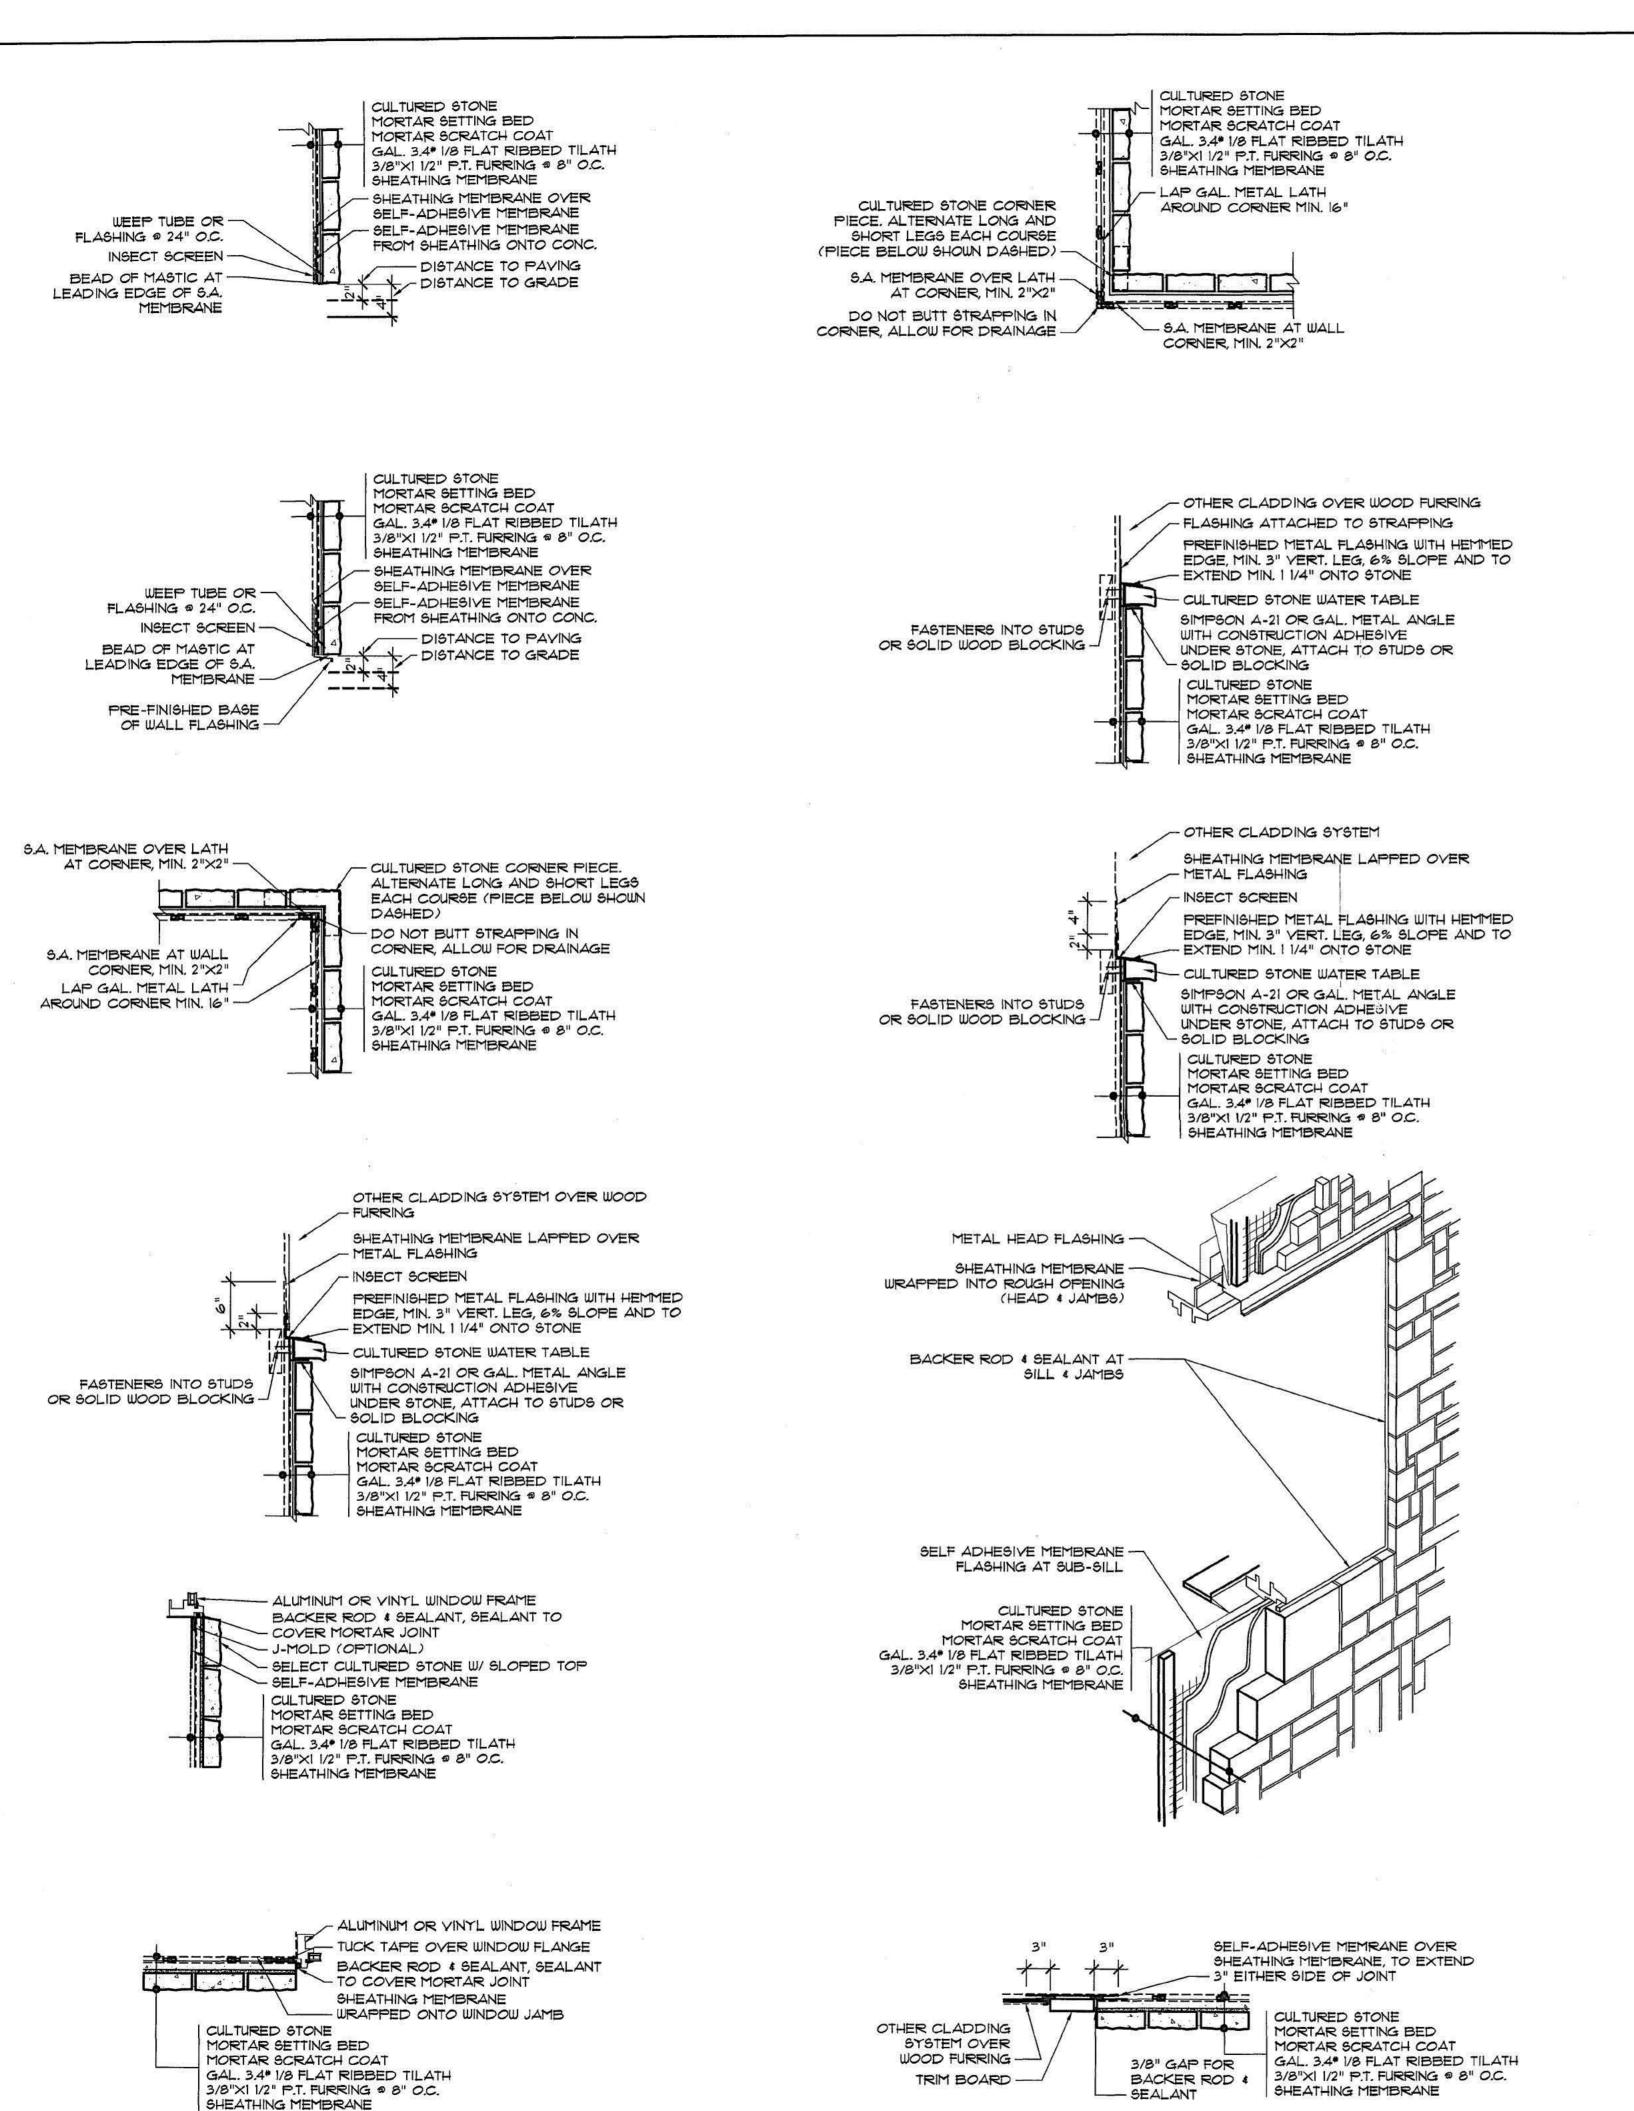

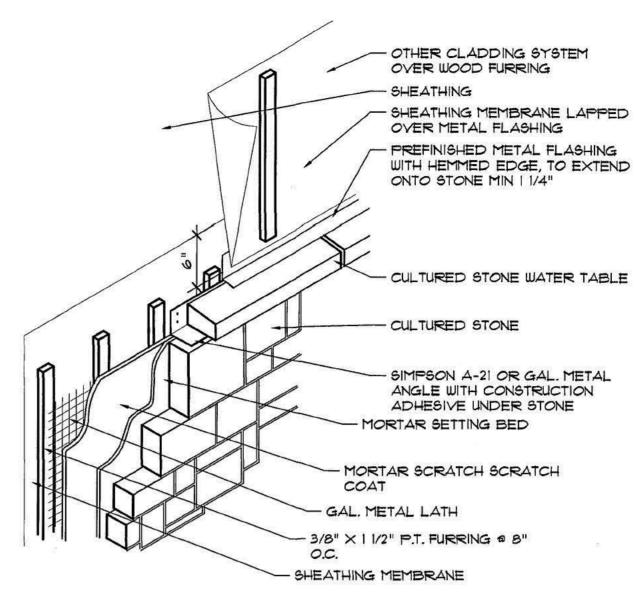

- WINDOW PRE-STRIP

- 1/4" MIN GAP

CULTURED STONE

OTHER CLADDING SYSTEM

PREFINISHED METAL TRIM

FLASHING, MIN 3" VERTICAL

SELF ADHESIVE MEMBRANE

TO LAP OVER & DOWN

- FACE OF TRIM BOARD

PREFINISHED METAL TRIM

FLASHING, MIN 3" VERTICAL

GAL. 3.4* 1/8 FLAT RIBBED TILATH 3/8"XI 1/2" P.T. FURRING \$ 8" O.C.

- HORIZ. TRIM BOARD

- LEG, MIN 6% SLOPE

CULTURED STONE MORTAR SETTING BED MORTAR SCRATCH COAT

SHEATHING MEMBRANE

- 1/4" MIN GAP


-1/4" MIN GAP - INSECT SCREEN


SHEATHING MEMBRANE LAPPED

- OVER WOOD FURRING

- OVER METAL FLASHING

- LEG, MIN 6% SLOPE

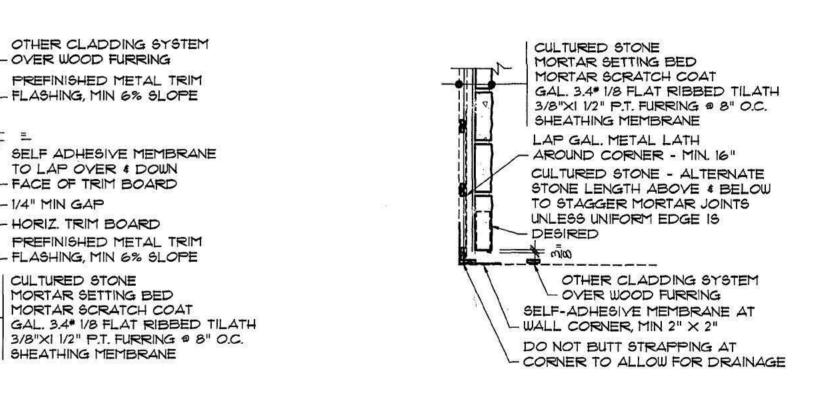

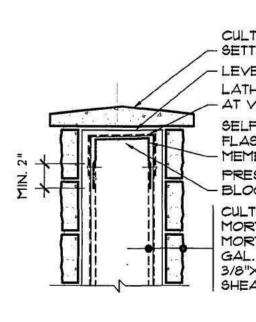

CULTURED STONE CAP IN MORTAR SETTING BED - LEVEL STRATCH COAT AT TOP OF WALL LATH OVER TOP OF WALL, FASTEN LATH - AT VERTICAL WALL FACES ONLY SELF-ADHESIVE MEMBRANE CAP FLASHING LAPPED 2" OVER SHEATHING MEMBRANE

PRESSURE TREATED BEVELLED WOOD BLOCKING CULTURED STONE MORTAR SETTING BED MORTAR SCRATCH COAT GAL. 3.4* 1/8 FLAT RIBBED TILATH 3/8"×1 1/2" P.T. FURRING @ 8" O.C. SHEATHING MEMBRANE



State of the contract of the c

Drawings to be read in conjunction with each other, any discrepancies on drawings are to be reported to the designer before initiating work.

It is the Contractor's responsibility to ensure all

**DETAILS** 

scale

1" = 1'-0" UNO.


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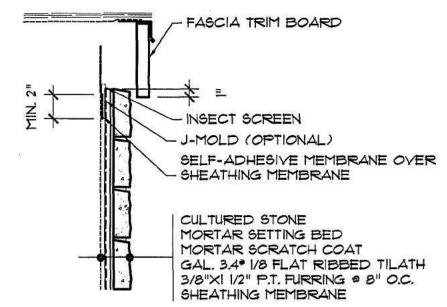
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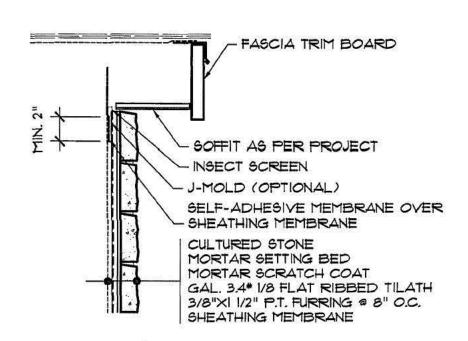
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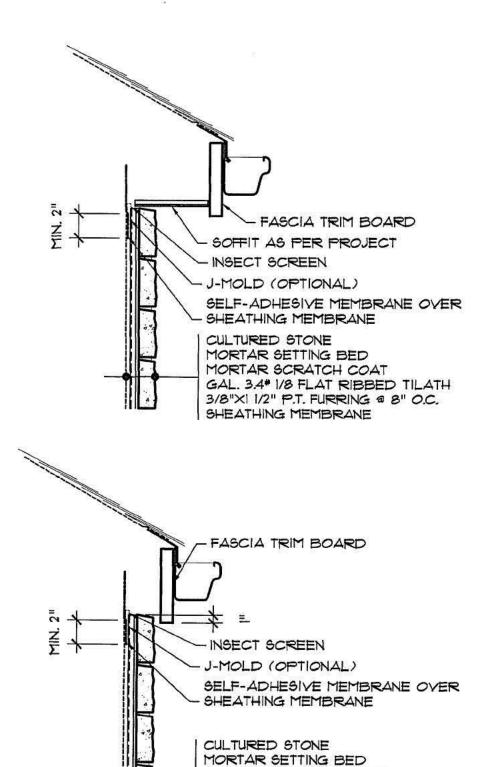
work is fulfilled in accordance to the requirements of the latest edition of the B.C. Building Code.

sheet no.








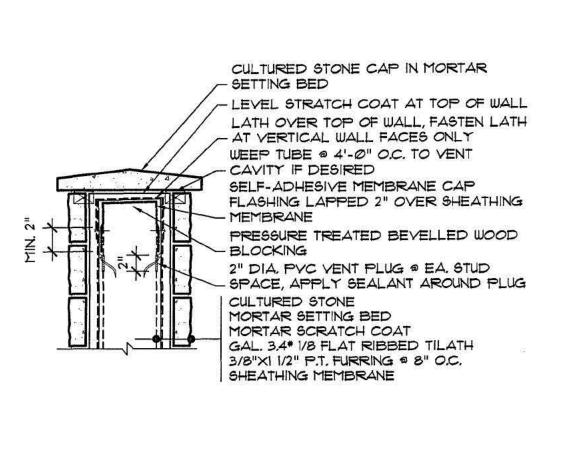



MORTAR SCRATCH COAT


SHEATHING MEMBRANE


GAL. 3.4* 1/8 FLAT RIBBED TILATH 3/8"X1 1/2" P.T. FURRING @ 8" O.C.

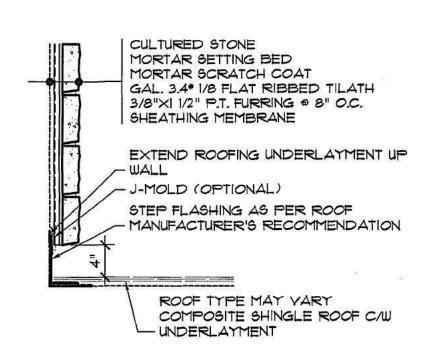


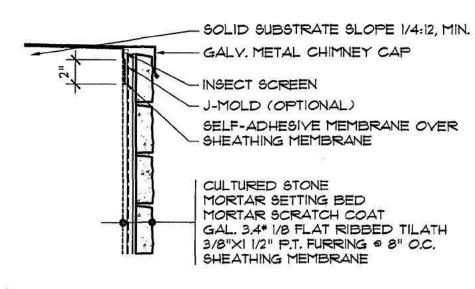


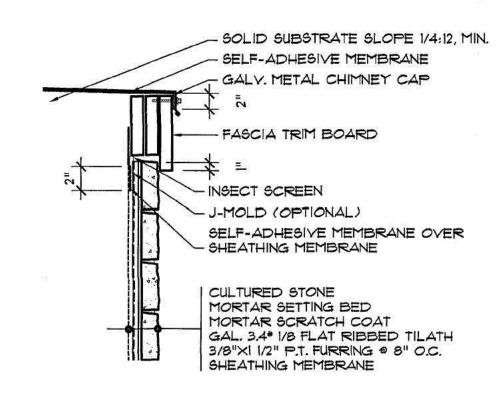


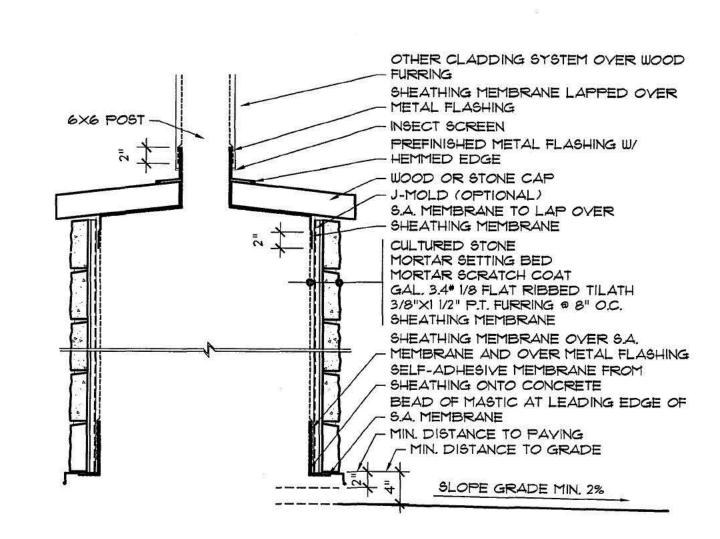

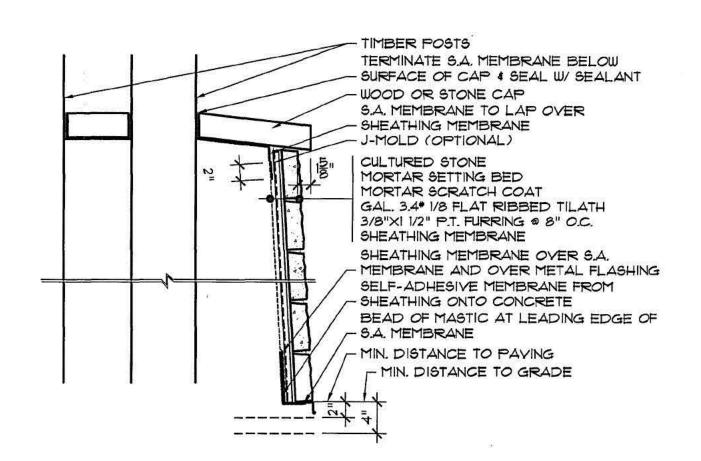


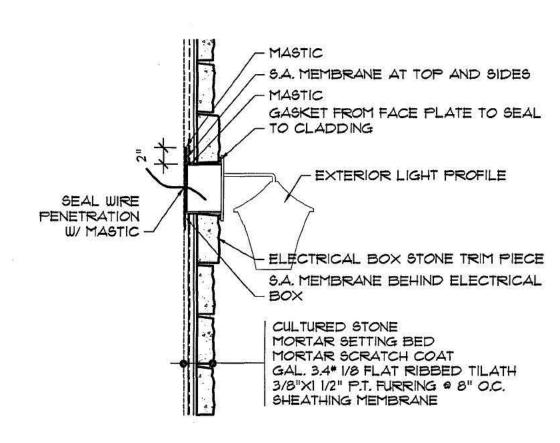


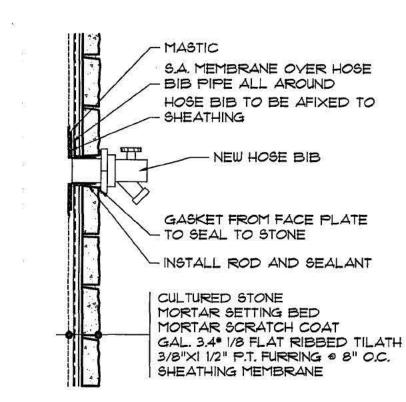


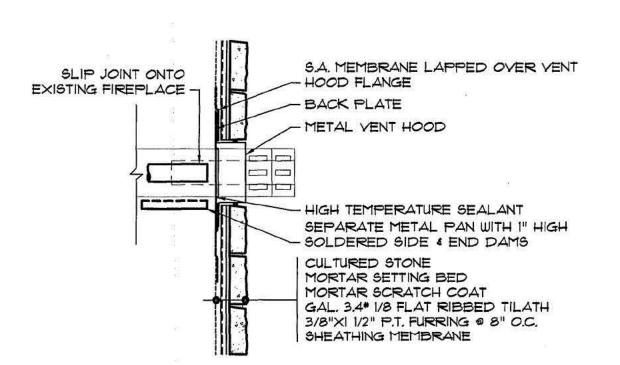



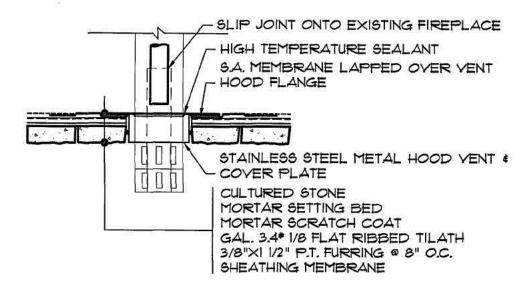


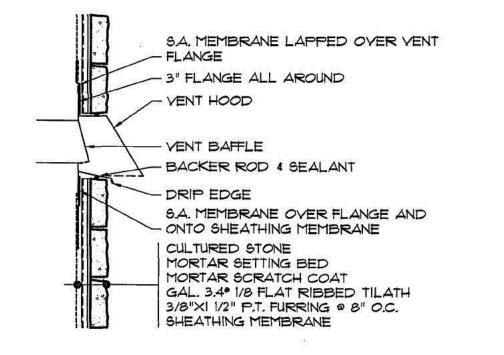

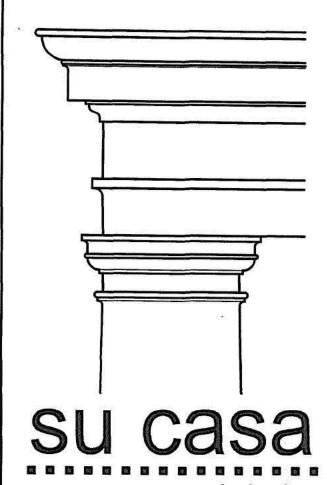

design inc.


30111 downes road mt. lehman, b.c., V4X 1Z8 Tel. (604) 856-3222 Fax (604) 854-4303

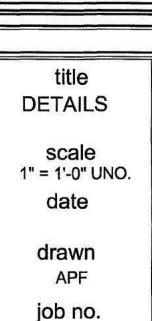


sheet no.

Drawings to be read in conjunction with each other, any discrepancies on drawings are to be reported to the designer before initiating work.

It is the Contractor's responsibility to ensure all work is fulfilled in accordance to the requirements of the latest edition of the B.C. Building Code.

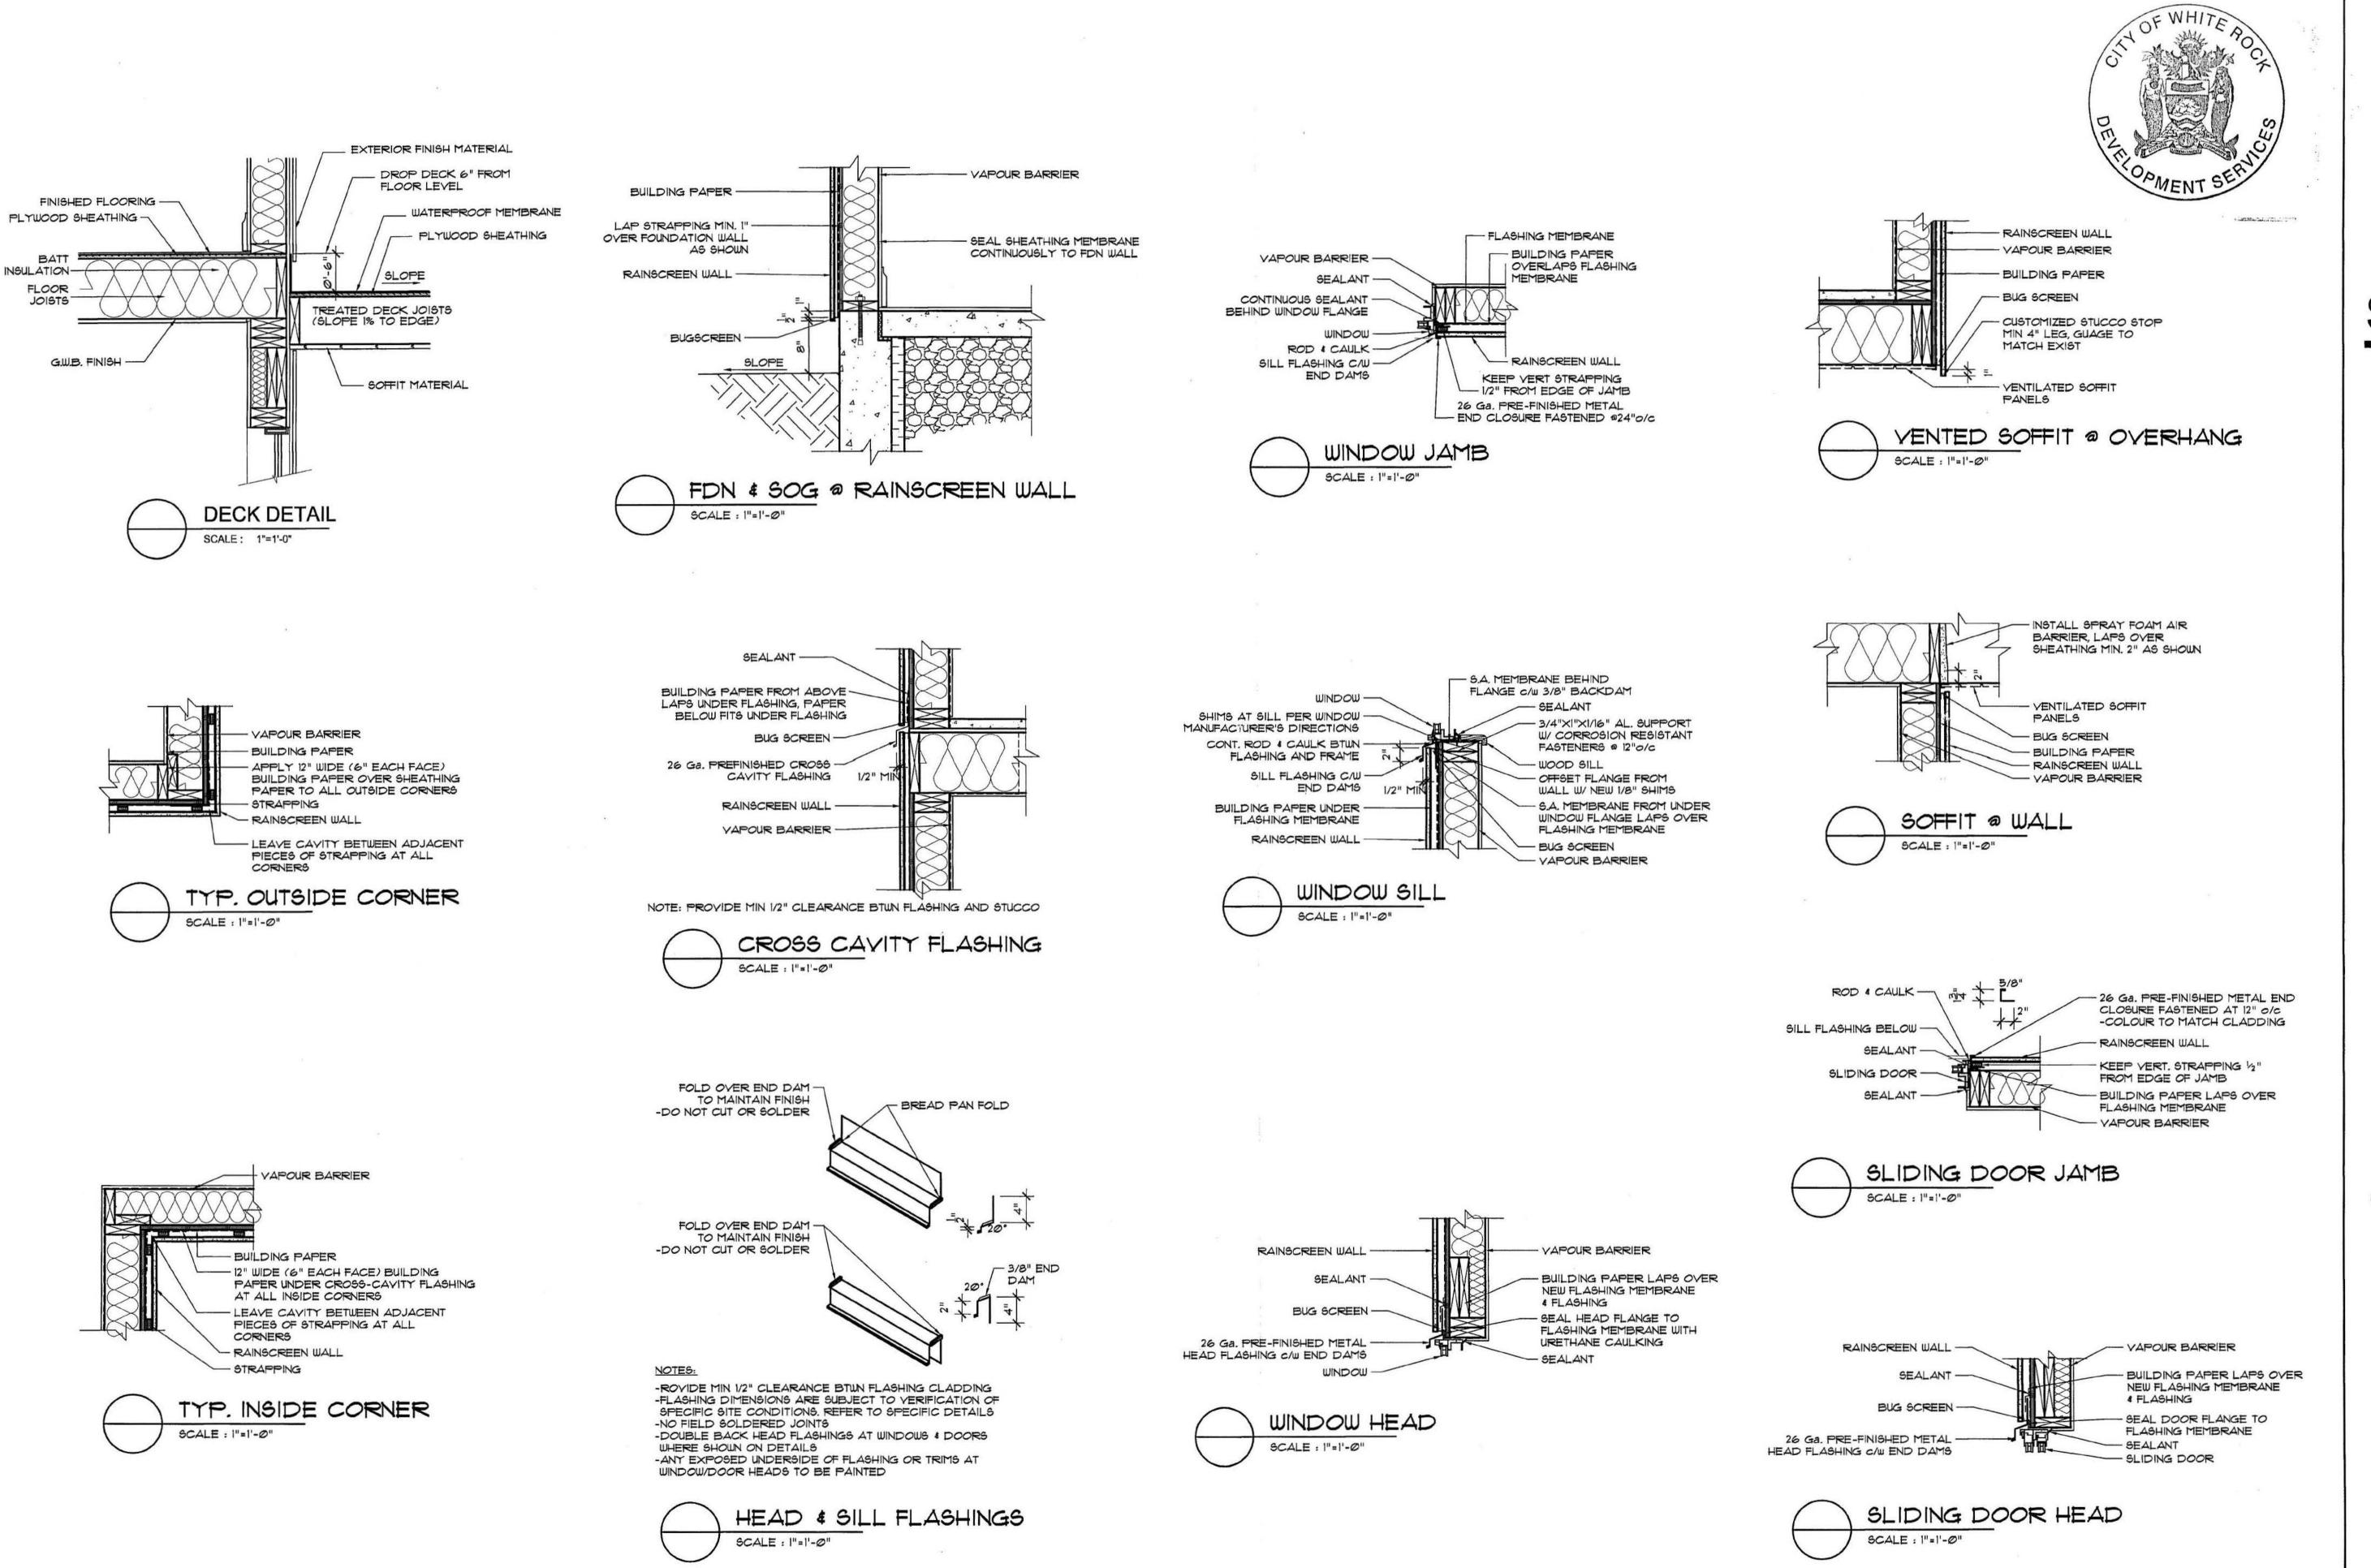

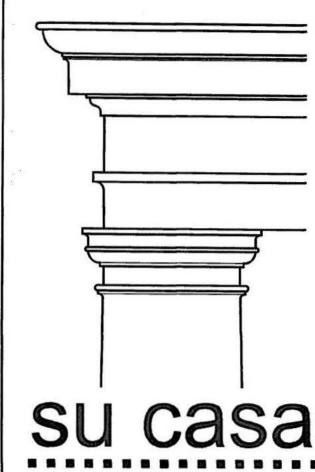

design inc.


30111 downes road mt. lehman, b.c., V4X 1Z8 Tel. (604) 856-3222 Fax (604) 854-4303

title **DETAILS** scale 1" = 1'-0" UNO. date drawn job no.


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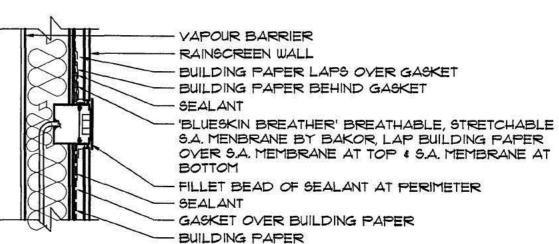
It is the Contractor's responsibility to ensure all work is fulfilled in accordance to the requirements of the latest edition of the B.C. Building Code.






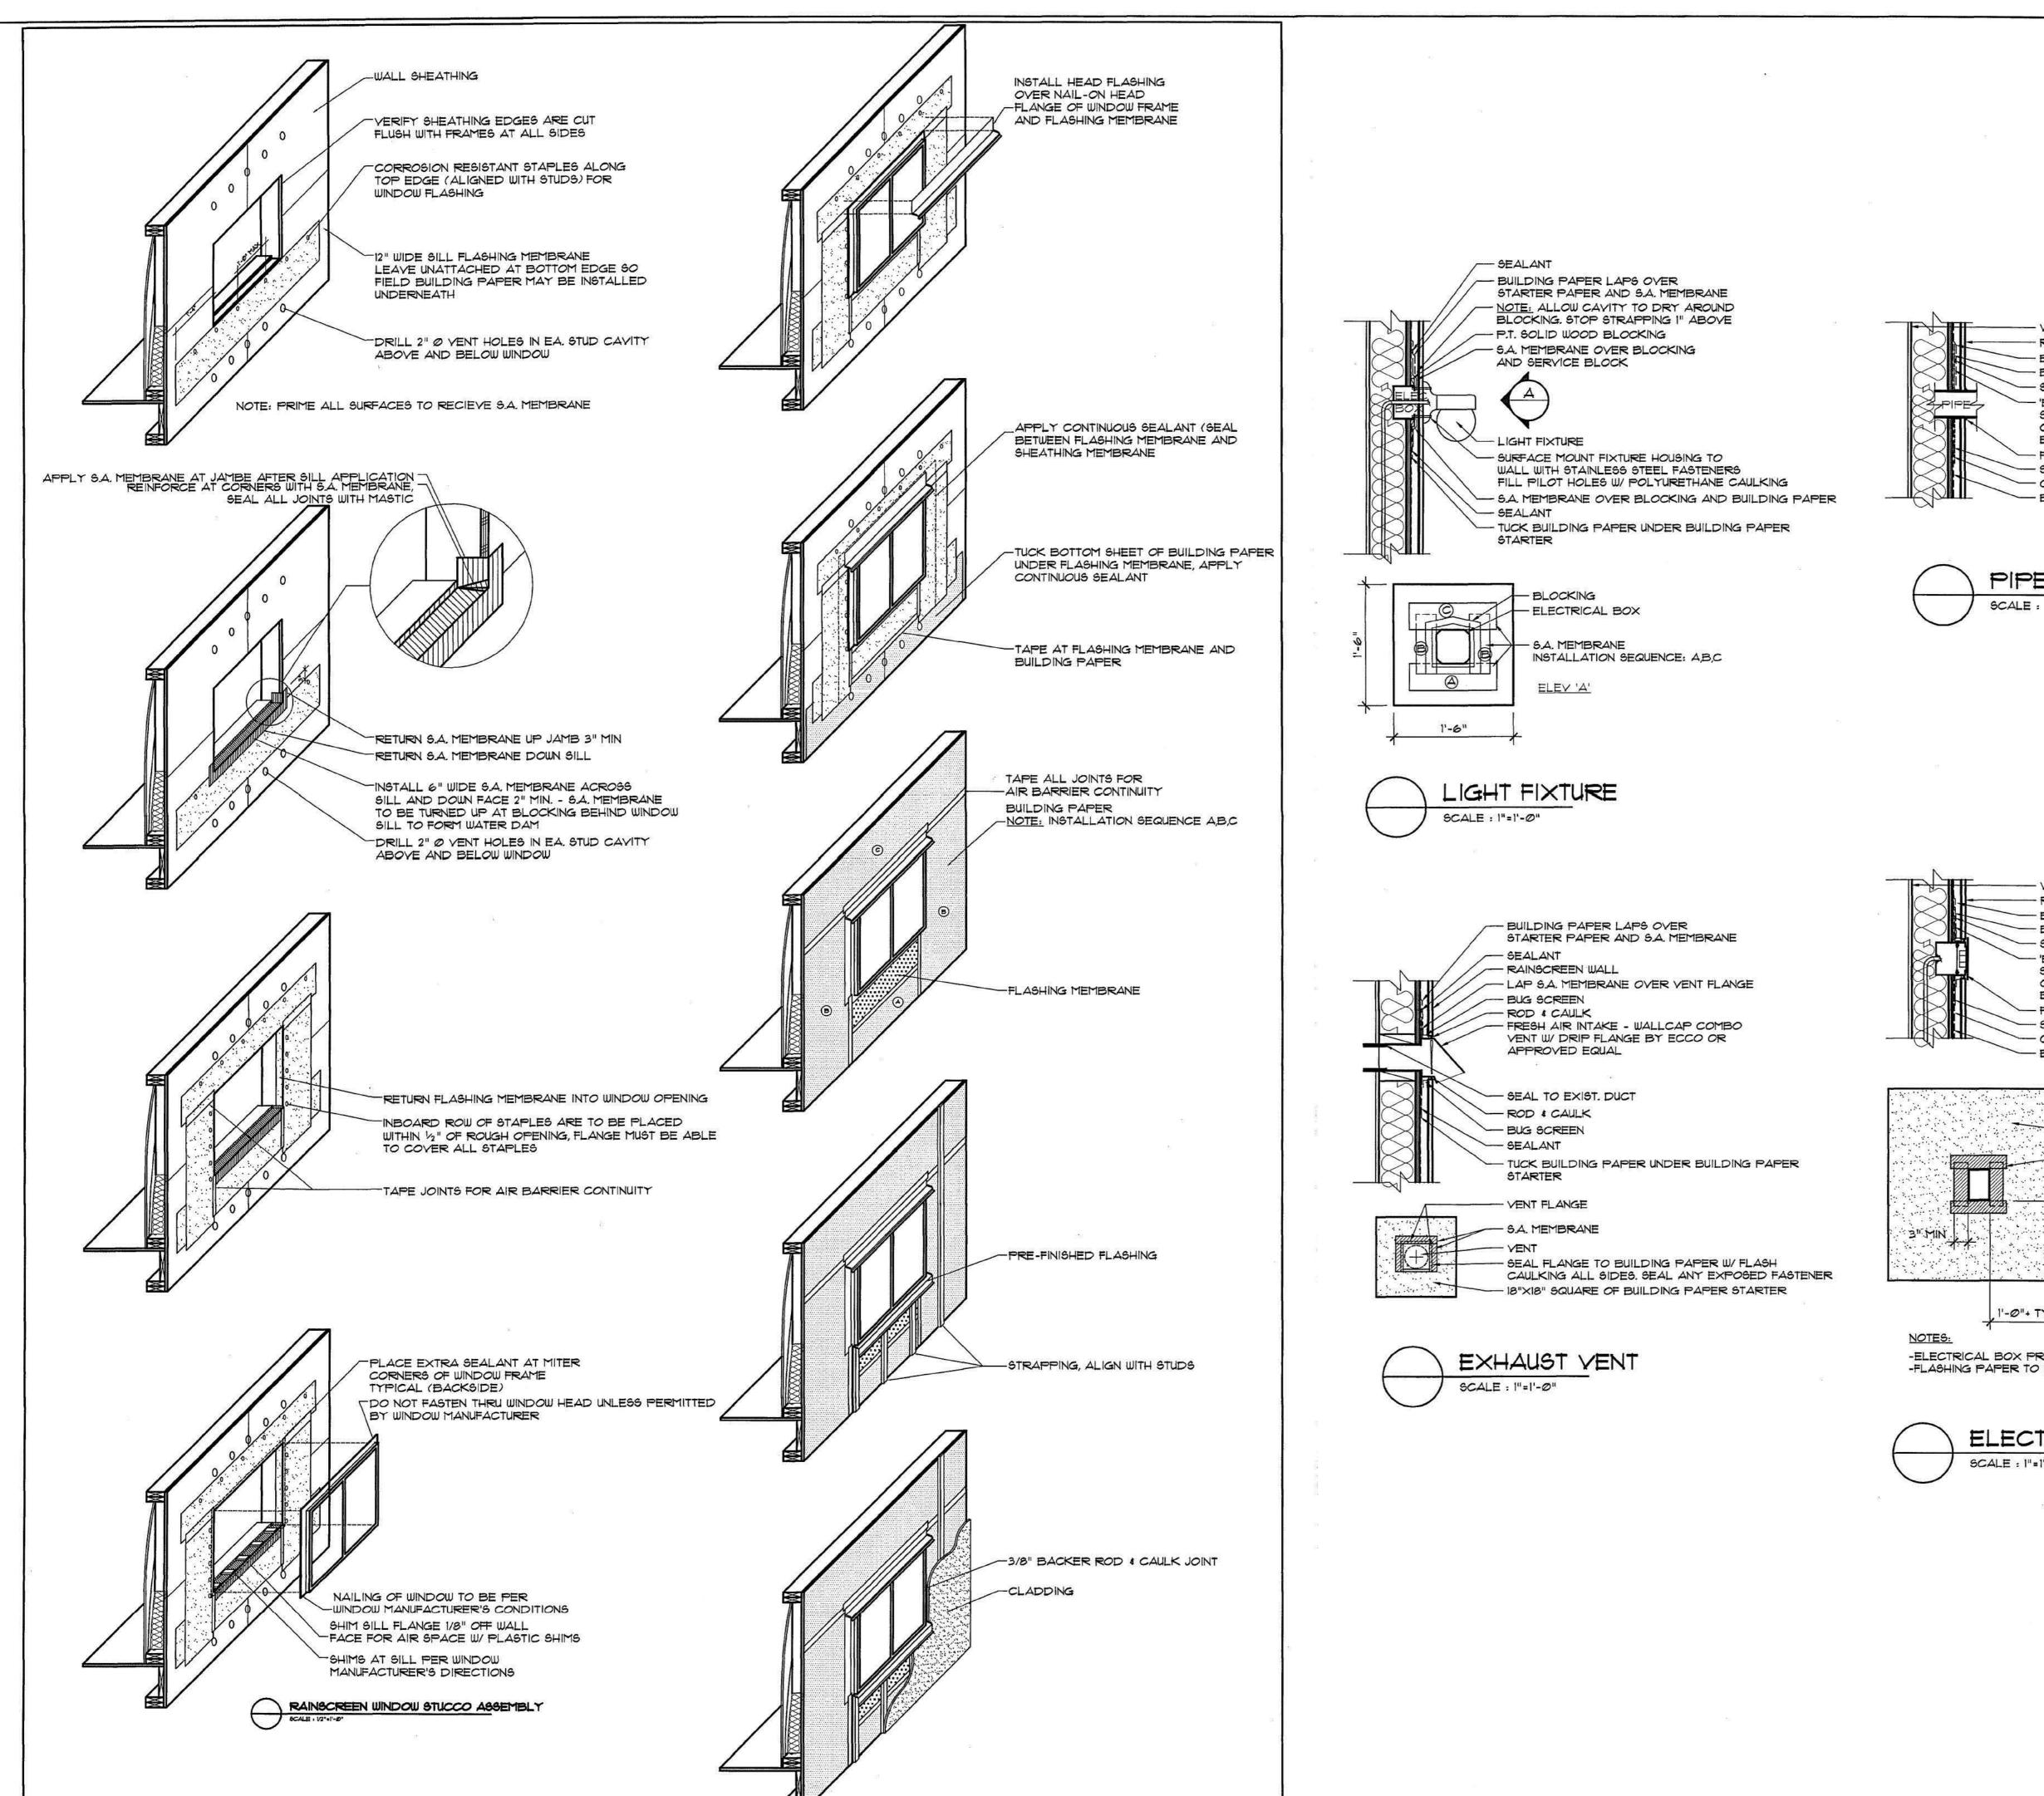




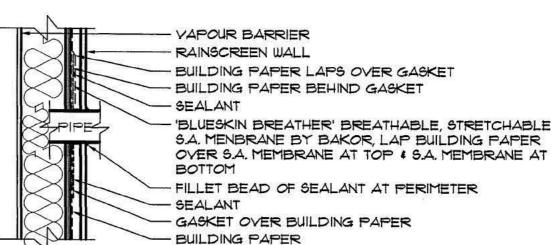

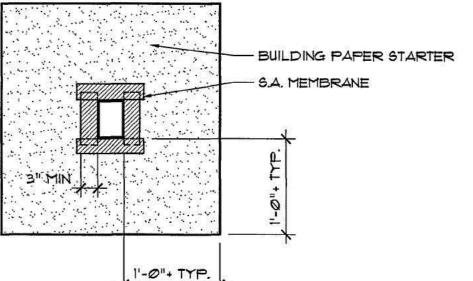

NOTES:
-ELECTRICAL BOX PROFILE MAY VARY.
-FLASHING PAPER TO BE 12" WIDER THAN BOX ALL AROUND



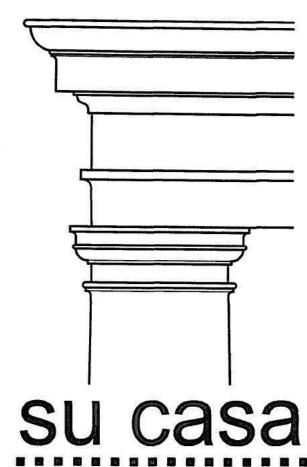

design in

70111 downes road mt. lehman, b.c., V4X 1Z8 Tel. (604) 856-3222 Fax (604) 854-4303

TYPICAL STUCCO DETAILS

title
DETAILS

scale
1" = 1'-0" UNO.
date


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APF
job no.


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Drawings to be read in conjunction with each other,


It is the Contractor's responsibility to ensure all work is fulfilled in accordance to the requirements of the latest edition of the B.C. Building Code.

any discrepancies on drawings are to be reported to the designer before initiating work.




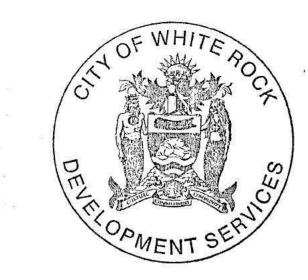

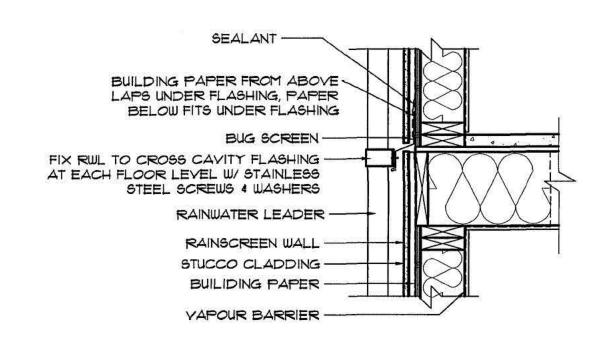


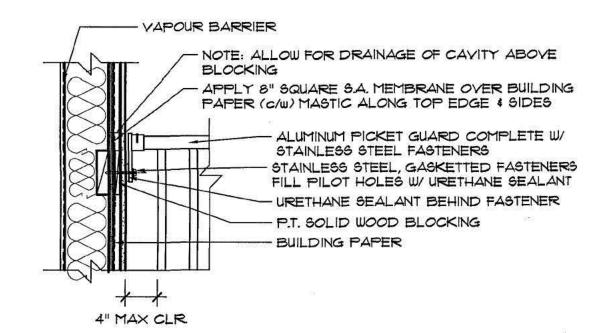




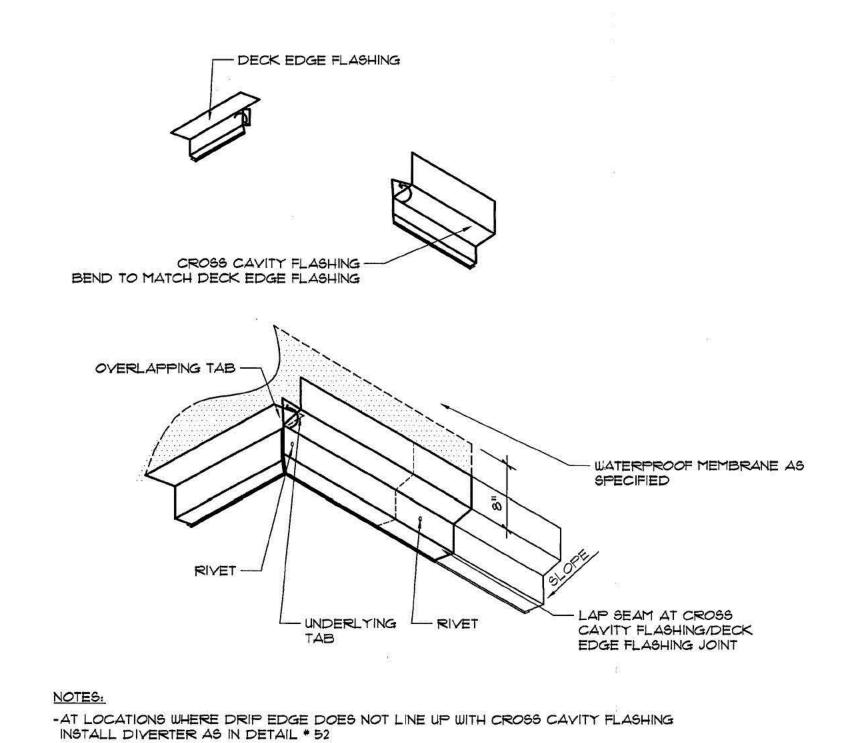

DECK EDGE/CROSS CAVITY FLASHING INTERFACE

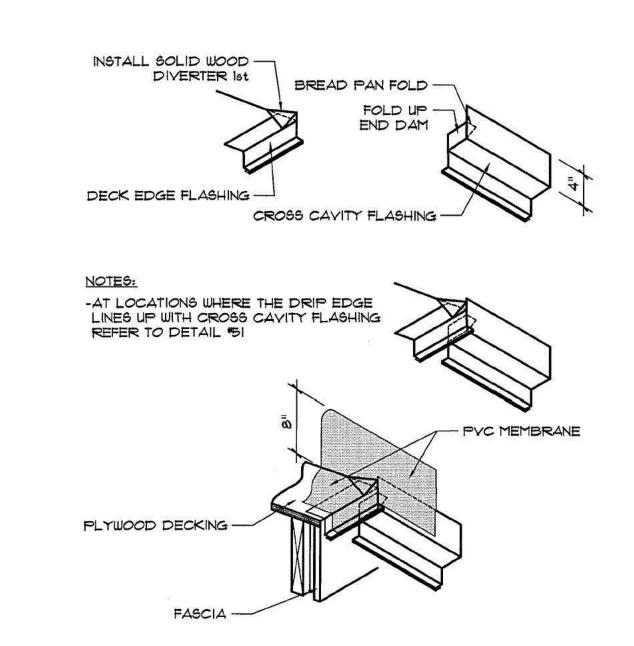




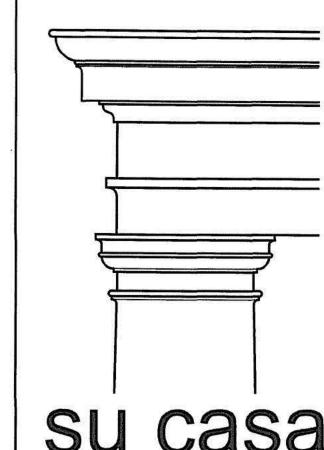

SU Casa design inc.

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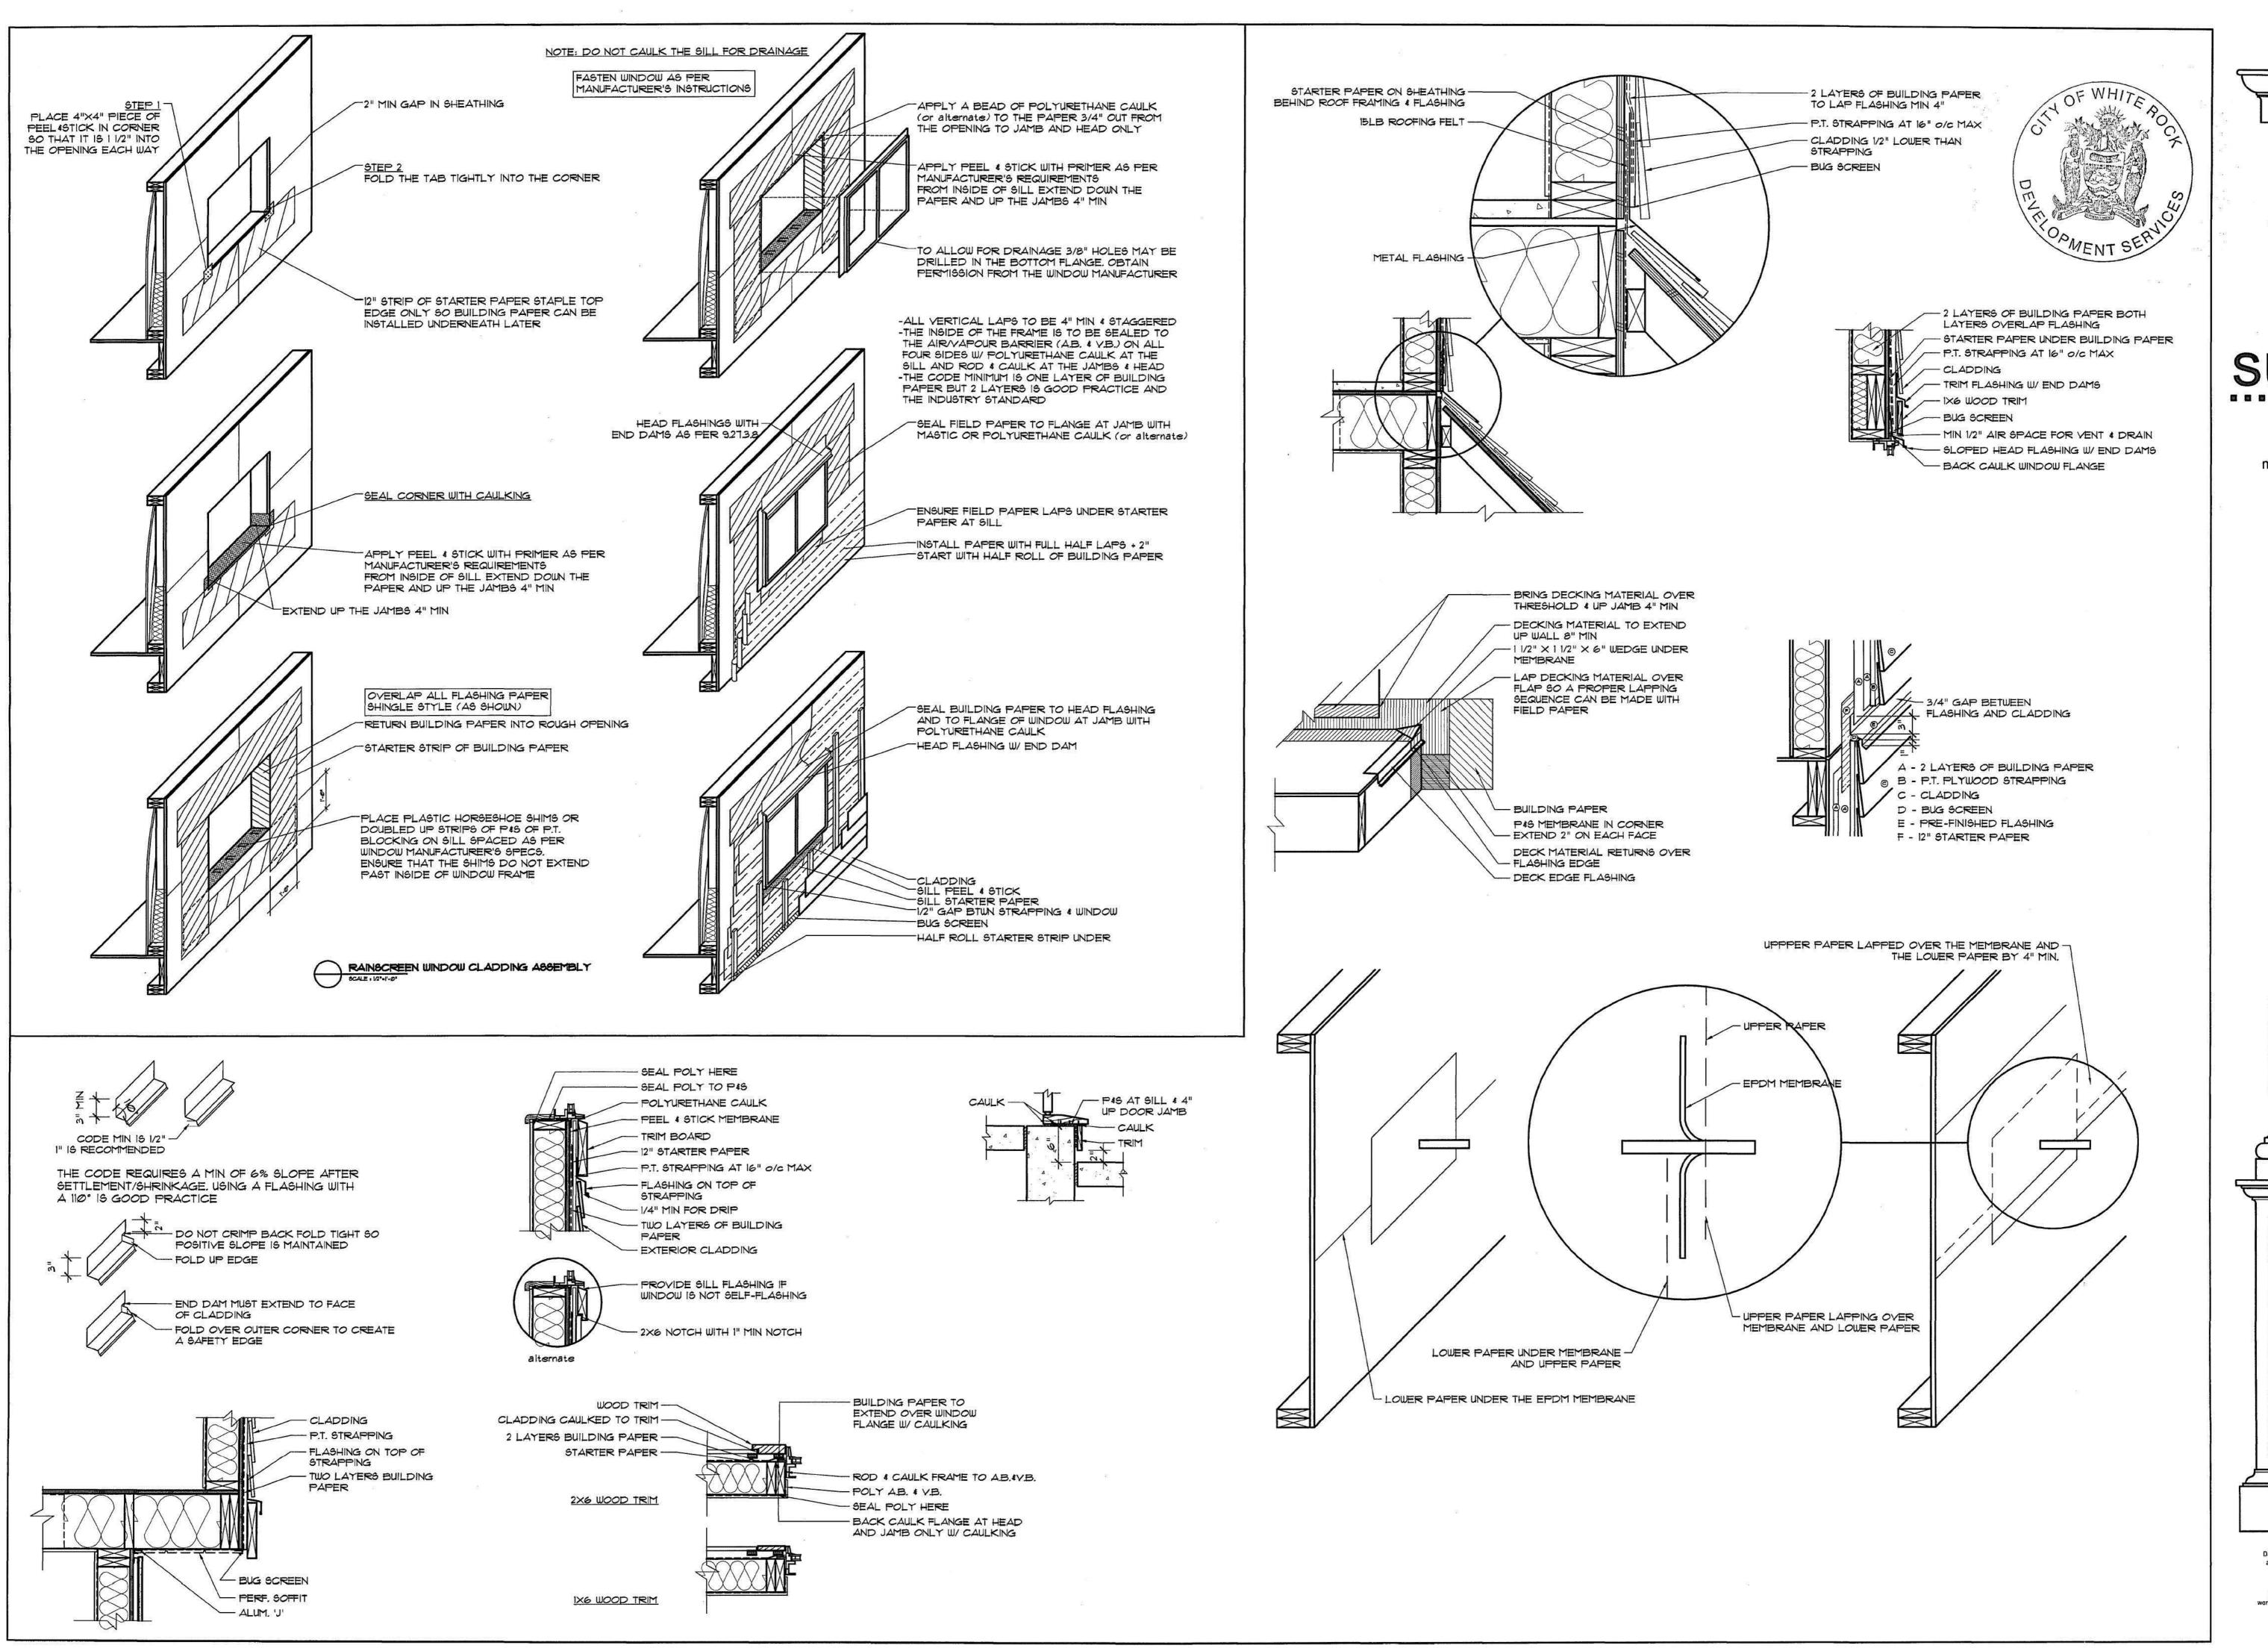
YPICAL STUCCO DETAILS

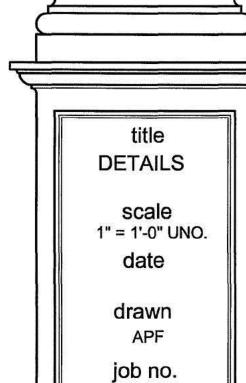

sheet no. A11

Drawings to be read in conjunction with each other, any discrepancies on drawings are to be reported to the designer before initiating work.


It is the Contractor's responsibility to ensure all work is fulfilled in accordance to the requirements of the latest edition of the B.C. Building Code.





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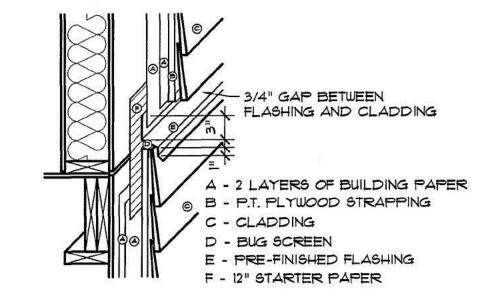
TYPICAL SIDING DETAILS

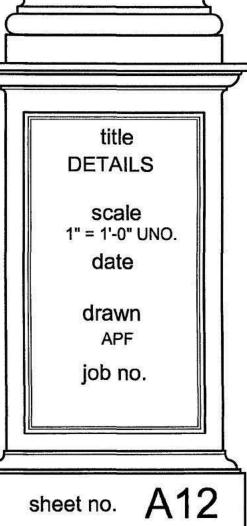



Drawings to be read in conjunction with each other, any discrepancies on drawings are to be reported to the designer before initiating work.


It is the Contractor's responsibility to ensure all work is fulfilled in accordance to the requirements of the latest edition of the B.C. Building Code.







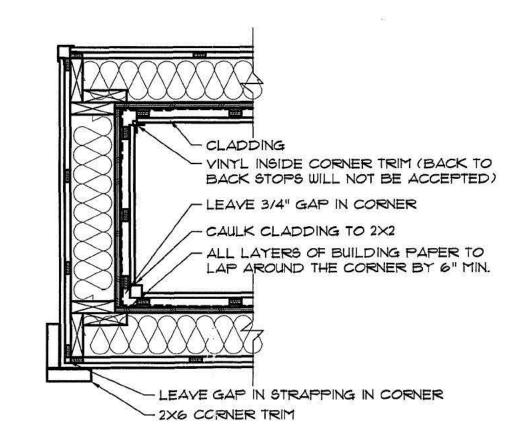


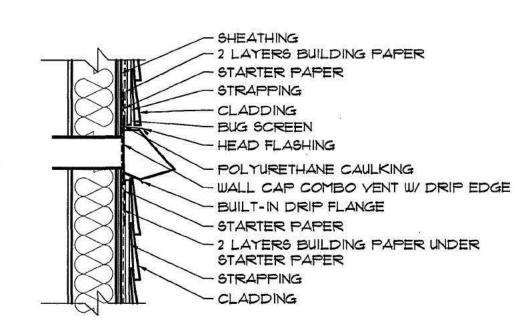


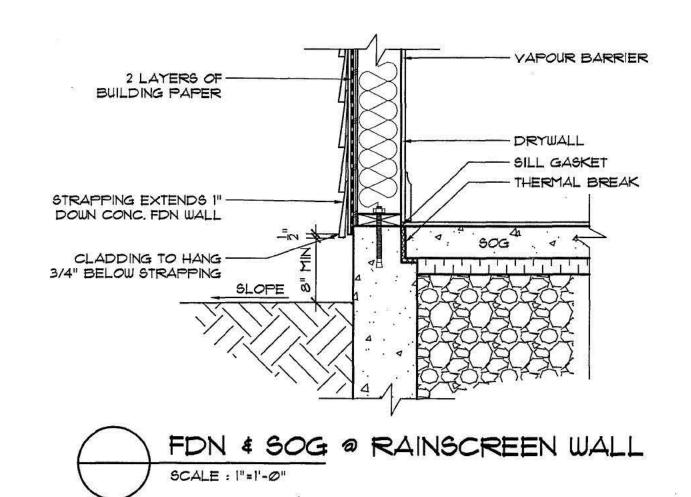

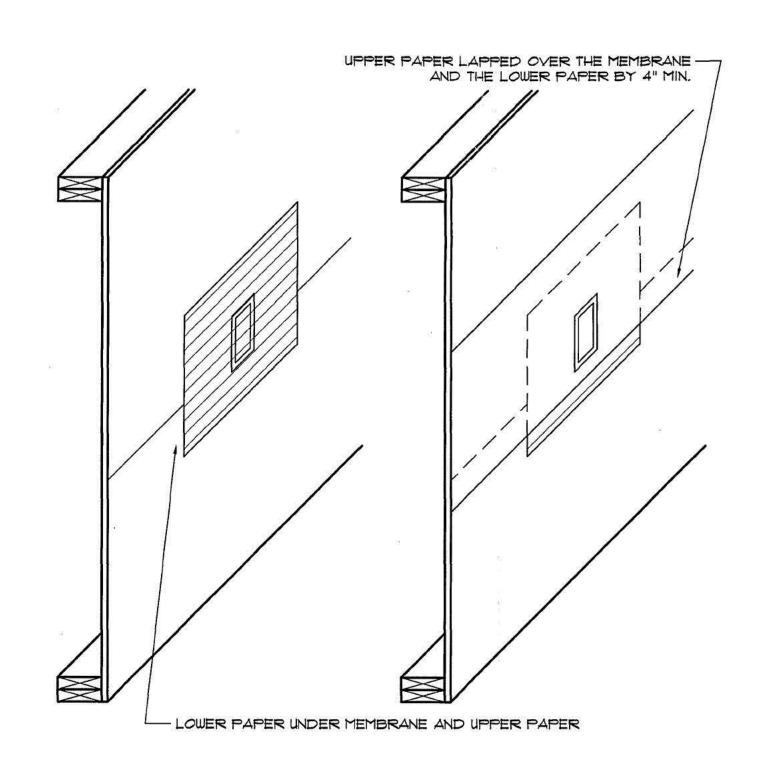

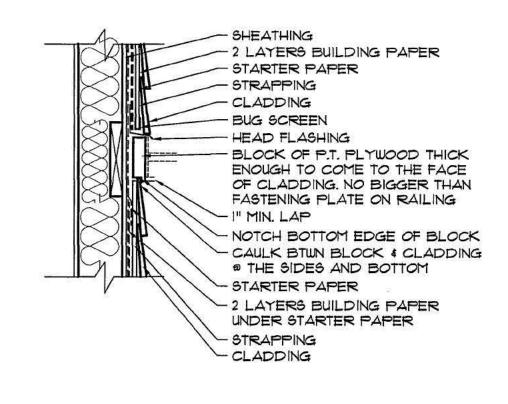

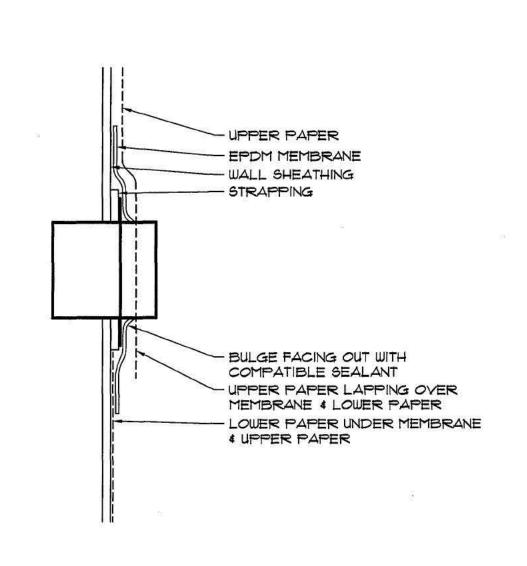

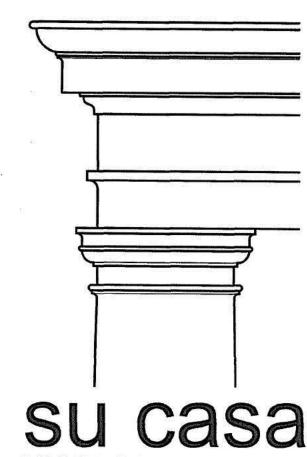

design inc.

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> A NG


scale

1" = 1'-0" UNO. drawn

sheet no. A13

Drawings to be read in conjunction with each other, any discrepancies on drawings are to be reported to the designer before initiating work.

It is the Contractor's responsibility to ensure all work is fulfilled in accordance to the requirements of the latest edition of the B.C. Building Code.

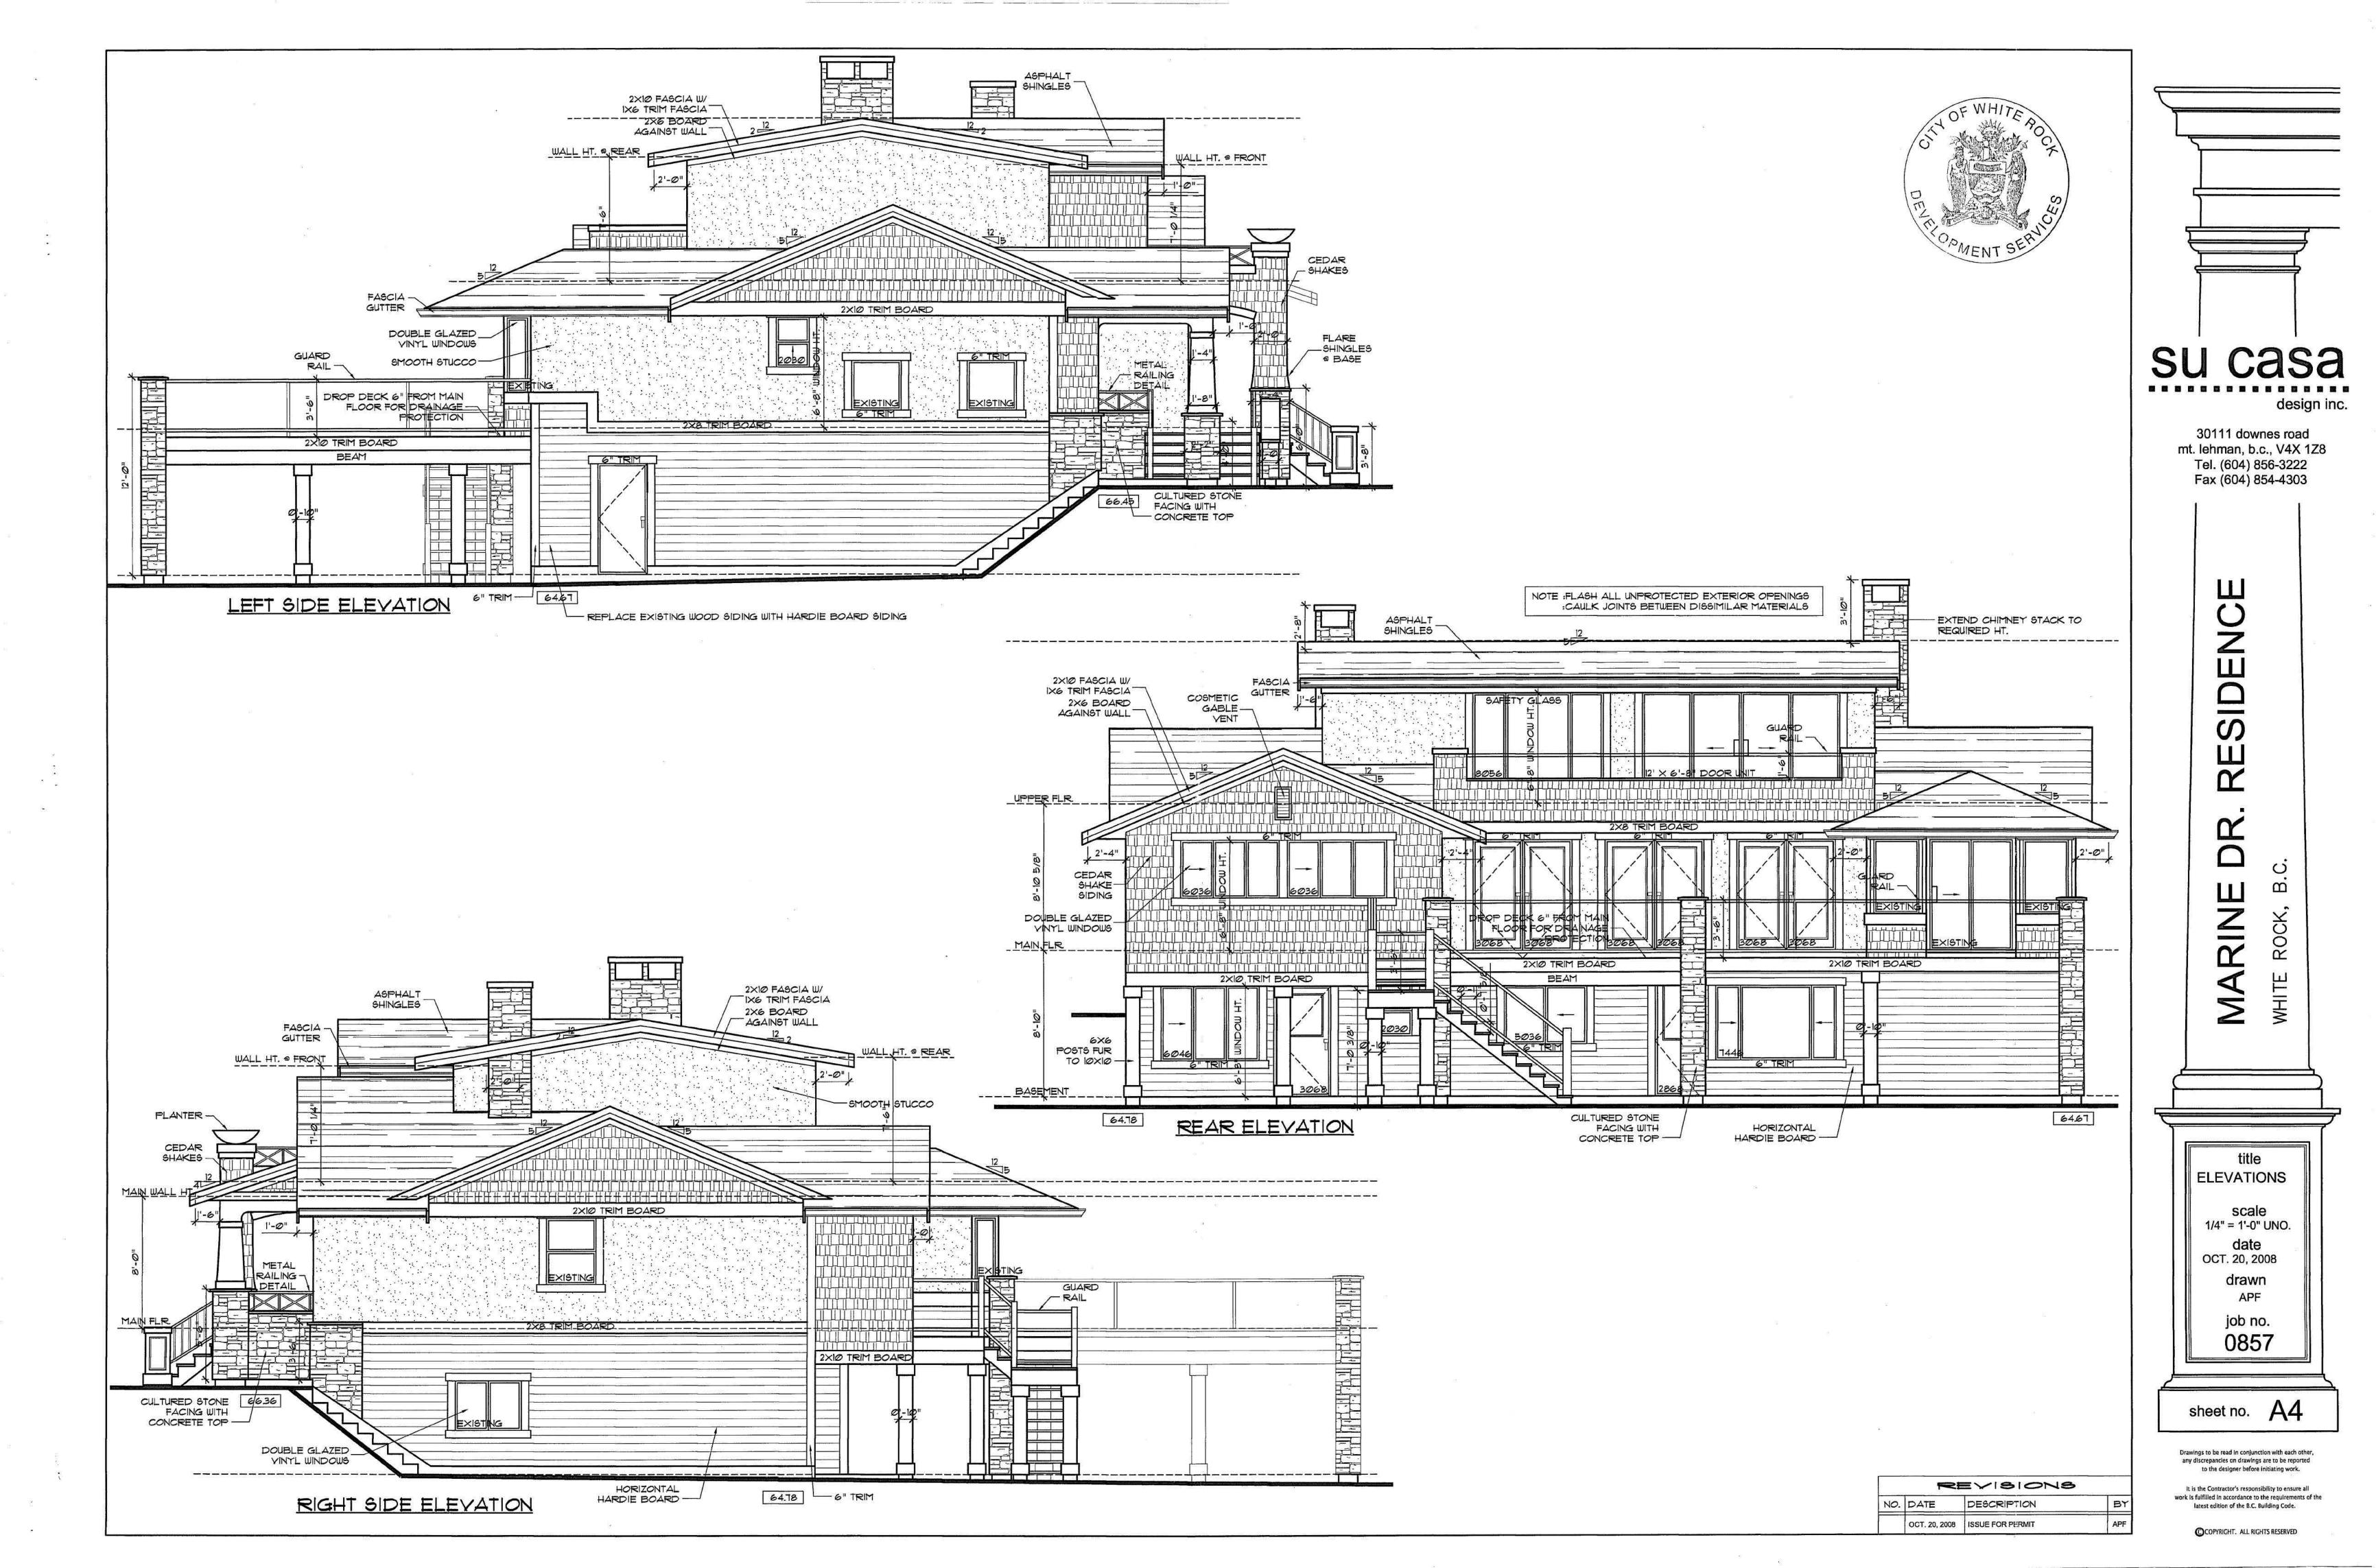



### **Authorization Form**

Planning and Development Services Department 15322 Buena Vista Ave., White Rock, B.C. V4B 1Y6 Phone: 604 541 2136 Fax: 604 541 2153 Website: www.whiterockcity.ca

				10072 00790		
Civic Address:	14034	Marine	Prive.	White	Rock	V4B1A7
Legal Description: _						
This document shall so of the property descri Agent") to act on my/d above referenced pro requirements and aut	bed above an our behalf on perty. In add	d do authori: all matters p ition, I/we ha	ze the perso ertaining to we read and	on(s) indicat the referend d understan	ed below ( ced applica	"Authorized ation for the
Name of Property Ow	ner(s):	Redacte	d S. 22			
Mailing Address:	89 S	14034 W	larine 9	Drive,	•	
	(	city: White	ROCK	Postal 0	code: V4	BIAT
	E	E-mail: Re	dacted	S. 22	*	
	F	Phone: Red	acted S	. 22 Fax:		
Name of Authorized A	\gent: _	Peter	Ngu		; ;	
Company Name:	э —	Wesen	Investor	1ents	Group:	MC.
Mailing Address:	-	TH3-6	080 M1	noru B	lvd,	
8	c	ity: <u>Rich</u>	mond	Postal Cod	le: <u>V6</u>	14A7
	E	-mail:	terngu	ca @g	mail . cu	m/
		hone: 604		_ 0	(2)	
Signature of Property	Owner(s)	edacte	ed S. 2	<b>22</b> _Date:	120	boll
Signature of Property	Owner(s):			Date:		
Signature of Authorize	ed Agent:	20		Date:	5/19	1/2015

Note: All registered owners of the property shall sign this Authorization Form. Use additional sheets if necessary. A new Authorization Form shall be submitted to the City of White Rock if the ownership of the property changes prior to completion of any application process.

MS SITESURV

15.00

15.00

22/

R:171538 / B:2015052201 / D:3672 May/2015 LORI

From: Sandeep Dhillon
To: Redacted S. 22

**Subject:** RE: 14034 Marine Dr (Bed and Breakfast requirements)

**Date:** Tuesday, April 11, 2017 10:46:00 AM

#### Hi Redacted S. 22

You will have to suspend the illegal business until further notice to avoid fines. Also, you will have to remove all ads showing your airbnb.

Thank You!

#### SANDEEP DHILLON BYLAW OFFICER

T. 604-541-2146 15322 Buena Vista Avenue

F. 604-541-2153 White Rock BC, V4B 1Y6



From: Redacted S. 22

Sent: Monday, April 10, 2017 7:27 AM

To: Sandeep Dhillon

**Subject:** Re: 14034 Marine Dr (Bed and Breakfast requirements)

Dear Sandeep Dhillon:

Good morning, very pleased to receive your mail, thank you for your help, let me understand the Whiterock B & B related content, understand that the owner needs to live in the house can operate B & B, in view of my I can not move back to Whiterock, So want to wait until I moved back to Whiterock and then apply to the government, once again thank you for your warm help, have a nice day!

Best Regards

#### Redacted S. 22

发**自** Windows 邮件

发**送**时间: 2017年4月6日, 星期四 16:31

收件人: Redacted S. 22

#### Hi Redacted S. 22

I have attached the Information for you. Please let me know if you have any further questions.

Regards,

#### SANDEEP DHILLON

#### **BYLAW OFFICER**

T. 604-541-2146 15322 Buena Vista Avenue

F. 604-541-2153 White Rock BC, V4B 1Y6

